- ALL WORK SHALL COMPLY WITH REQUIREMENTS OF THE STATE OF KANSAS, REQUIREMENTS OF KANSAS STATE UNIVERSITY, AND ALL APPLICABLE BUILDING CODES.
- CONTRACTOR SHALL VERIFY ALL DIMENSIONS AND EXISTING CONDITIONS. ANY DISCREPANCIES BETWEEN THE EXISTING CONDITIONS AND DRAWINGS SHALL BE BROUGHT IMMEDIATELY TO THE ATTENTION OF THE ARCHITECT PRIOR TO CONSTRUCTION.
- CONTRACTOR SHALL USE EXTREME CARE AND TAKE PRECAUTION DURING CONSTRUCTION SO AS NOT TO DAMAGE EXISTING ADJACENT FACILITIES. ANY DAMAGE DONE TO EXISTING FACILITIES DURING CONSTRUCTION SHALL BE REPAIRED TO THE SATISFACTION OF THE OWNER'S REPRESENTATIVE WITHOUT ADDITIONAL COST TO THE
- ALL DIMENSIONS ARE NOMINAL AND ARE FINISH TO FINISH OR FACE TO FACE OF CONSTRUCTION UNLESS OTHERWISE NOTED.
- UNLESS OTHERWISE NOTED. CONTRACTOR SHALL PATCH OR REPAIR. PAINT OR RESTORE AND REFINISH (AS APPLIES) ALL ADJACENT SURFACES AFFECTED BY NEW CONSTRUCTION OR DEMOLITION. USE MATERIALS TO MATCH EXISTING.
- CONTRACTOR SHALL REMOVE ALL TRASH AND DEBRIS FROM THE SITE ON A DAILY BASIS. COORDINATE DUMPSTER LOCATION AND ACCESS WITH THE OWNER'S
- SHOULD ANY DOUBT OR QUESTION ARISE WITH RESPECT TO THE TRUE MEANING OF THE DRAWINGS OR SPECIFICATIONS, REFERENCE SHALL BE MADE TO THE ARCHITECT WHOSE DECISIONS THEREON SHALL BE FINAL AND CONCLUSIVE.
- THE CONTRACTOR IS RESPONSIBLE FOR TEMPORARY DIRECTIONAL AND EGRESS SIGNAGE AS WELL AS CONSTRUCTION SIGNAGE NOTIFYING THE PUBLIC OF
- CONSTRUCTION LIMITS. CONTRACTOR SHALL NOT ENGAGE IN ANY ACTIVITY WHICH MAY ENDANGER THE PUBLIC.
- CONTRACTOR IS REQUIRED, PRIOR TO THE START OF CONSTRUCTION, TO SURVEY THE AREAS WHICH WOULD BE AFFECTED BY THE CONSTRUCTION FOR DOCUMENTATION OF
- 11. ALL DIMENSIONS OF EXISTING CONSTRUCTION ARE TO PROVIDE THE CONTRACTOR WITH APPROXIMATE SIZES AND ARE NOT INTENDED TO BE USED FOR CONSTRUCTION PURPOSES. ALL DIMENSIONS SHOULD BE FIELD VERIFIED BY THE CONTRACTOR PRIOR TO THE START OF CONSTRUCTION.
- PRIOR TO INTERRUPTION OF BUILDING SERVICES, COORDINATE SHUTDOWNS WITH OWNER'S REPRESENTATIVE WELL IN ADVANCE OF SCHEDULED TIME REQUIRED.
- MAINTAIN THE INTEGRITY OF ALL EXISTING RATED WALLS.
- DO NOT SCALE THESE DRAWINGS. WORK FROM DRAWING DIMENSIONS.
- THESE DRAWINGS AND NOTES ESTABLISH THE MINIMUM REQUIREMENTS FOR THIS PROJECT
- COORDINATE ALL TRADES INVOLVED.
- 17. VERIFY ALL CONDITIONS AND DIMENSIONS ON THE SITE.
- THIS PROJECT HAS BEEN REVIEWED BY THE OFFICE OF CAMPUS PLANNING & FACILITIES MANAGEMENT. ANY DEVIATION FROM PLANS MUST BE NOTED AND REVIEWED BY SAID
- ONE SET OF CONSTRUCTION DOCUMENTS SHALL BE KEPT ON SITE DURING ALL PHASES OF CONSTRUCTION.
- 20. ALL EXISTING CONDITIONS OR BUILDING MATERIALS DAMAGED BY CONSTRUCTION SHALL BE REPAIRED OR REPLACED TO MATCH ORIGINAL CONDITIONS.
- BEFORE COMMENCING WORK, COORDINATE WITH THE OFFICE INVOLVED AND AFFECTED BY THE PROJECT.
- 22. ONE SET OF 'AS-BUILT' DRAWINGS SHALL BE DELIVERED TO THE OFFICE OF CAMPUS PLANNING & FACILITIES MANAGEMENT UPON COMPLETION OF THE PROJECT IF ITEMS OF WORK ARE GOING TO BE CONCEALED WHICH ARE NOT INCLUDED IN DRAWINGS.
- SHOP DRAWINGS FOR MA IOR DURCHASED FOLUDMENT / MATERIAL SYSTEM ITEMS SHALL BE SUBMITTED TO THE ARCHITECT/ENGINEER AND THE OFFICE OF CAMPUS PLANNING & FACILITIES MANAGEMENT FOR APPROVAL PRIOR TO INSTALLATION.
- ALL MATERIALS USED FOR THIS PROJECT SHALL BE ASBESTOS FREE CONTRACTOR TO SUBMIT M.S.D.S. TO THE OFFICE OF CAMPUS PLANNING & FACILITIES MANAGEMENT AT
- CONTRACTORS SHALL TAKE INTO CONSIDERATION THE ACADEMIC MISSION OF THE UNIVERSITY. CONSIDERATION NEEDS TO BE GIVEN FOR NOISY CONSTRUCTION ACTIVITIES, JACKHAMMER, CHIPPING HAMMER, HAMMER DRILLS AND SUCH, TO SCHEDULE THESE EARLY AM, LATE PM, OR WEEKEND, WITH NO ADDITIONAL COST TO THE BID SUBMITTED. PROVIDE NOTIFICATION TO THE DEPARTMENT, COORDINATED WITH AND BY KANSAS STATE UNIVERSITY OWNER'S REPRESENTATIVE. SO THAT IF THERE ARE IMPORTANT ACTIVITIES SCHEDULED FOR THE DEPARTMENT, WORK ACTIVITIES CAN BE SCHEDULED AROUND THOSE SCHEDULED ITEMS. MOST CONSTRUCTION ACTIVITIES CAN BE DONE THROUGHOUT THE DAY. HOURS OF WORK CAN BE 6:30 AM TO 10:00 PM. OTHER HOURS AS APPROVED BY KANSAS STATE UNIVERSITY. KANSAS STATE UNIVERSITY MAY HAVE SOME PERIODIC ACTIVITIES SCHEDULED IN ADJACENT ROOMS / OFFICES THAT WILL REQUIRE CONTRACTOR TO AVOID CERTAIN TYPES OF WORK DURING THOSE SPECIFIC TIMES. KSU WILL MAKE EVERY EFFORT TO NOTIFY THE CONTRACTOR OF THESE TIME PERIODS AS MUCH IN ADVANCE AS POSSIBLE.
- ALL WORK CONSIDERED HERE SHALL BE GOVERNED BY ALL RELEVANT NATIONAL AND STATE CODES AS FOLLOWS: 1. International Building Code (ICC), 2012 Ed.
  - a. Chapter 11, Accessibility is deleted. See ADA item below.
  - b. Life Safety Code (NFPA 101, 2006 Ed.) is applicable on projects required to meet
  - Federal requirements 2. International Building Fire Code (ICC), 2012 Ed.
  - International Mechanical Code (ICC), 2012 Ed. 4. International Plumbing Code (ICC), 2012 Ed.
  - 5. Kansas Fire Protection Code, Latest Edition National Electrical Code (NFPA 70), 2014 Ed.
  - 7. National Fire Alarm Code (NFPA 72), 2013 Ed 8. Portable Fire Extinguishers (NKPA 10), 213 Ed.
  - 9. Americans with Disabilities Act (ADAAG), 1991 Ed
  - 10. ADA Standards for Accessible Design, 2010 Ed. 11. Kansas State Boiler Code (KSA 44-913) 12. Kansas Fire Prevention Code (KSA 31-133 and KSA 31-134A)
- REMOVE OR DEMOLISH PORTIONS OF EXISTING FLOOR, WALL, AND CEILING FINISHES AS REQUIRED TO COMPLETE SCOPE OF WORK BY OTHER TRADES, AS DIRECTED BY KSU.

PATCH, REPAIR, AND FINISH TO MATCH ADJACENT SURFACES.

- PRIOR TO COMMENCING DEMOLITION WORK, THE CONTRACTOR SHALL VERIFY LOCATIONS OF ALL UTILITIES AND MAKE PROVISIONS THAT NO INTERRUPTION OF SERVICES OCCUR. COORDINATE ANY SERVICE INTERRUPTIONS WITH OWNER'S
- CONTRACTOR SHALL COMPLETELY REMOVE ALL DEMOLISHED MATERIALS FROM SITE. ALL DEMOLISHED MATERIALS WILL BECOME PROPERTY OF THE CONTRACTOR UNLESS THEY ARE TO BE REUSED, OR AS OTHERWISE NOTED OR INSTRUCTED, AND TO BE DISPOSED OF LEGALLY. REMOVE DEBRIS, RUBBISH, AND OTHER MATERIALS DAILY FROM CONSTRUCTION SITE.
- ALL MATERIALS NOT REQUIRED TO BE REMOVED FOR THE EXECUTION OF THE PROJECT SHALL BE LEFT IN PLACE AND PROTECTED FROM DAMAGE DURING DEMOLITION. ANY ITEMS DAMAGED DURING DEMOLITION SHALL BE RESTORED TO THEIR ORIGINAL CONDITION AT THE CONTRACTOR'S EXPENSE.
- THE OWNER ASSUMES NO RESPONSIBILITY FOR ACTUAL CONDITIONS OF ITEMS TO BE
- CUT AND REMOVE PORTIONS OF EXISTING CONSTRUCTION AS REQUIRED TO ALLOW FOR PROPER INSTALLATION OF NEW CONSTRUCTION.
- AT ANY TIME DURING DEMOLITION, IF ANY CONTRACTOR DISCOVERS HAZARDOUS MATERIALS, STOP WORK AND NOTIFY THE OWNER/ARCHITECT IMMEDIATELY.
- LEAVE ALL MAJOR STRUCTURAL COLUMNS AND BEAMS UNDISTURBED, U.N.O.
- ALL DOTTED LINES ON DEMOLITION PLANS INDICATE ITEMS TO BE REMOVED, U.N.O.
- ALL EXISTING HOLES AND OPENINGS DUE TO REMOVAL OF OBJECTS FROM THE FACE OF WALLS THAT ARE TO REMAIN SHALL BE INFILLED TO MATCH ADJACENT MATERIALS AND
- NEEDED. BLEND WITH EXISTING ADJACENT SURFACES IN ALL RESPECTS. ALL EGRESS ROUTES FOR EXITING SHALL BE MAINTAINED THROUGHOUT DURATION OF

FINISHES. PATCH IMPERFECTIONS AND DEFICIENCIES. REPLACE WITH NEW MATERIAL IF

THE OWNER HAS FIRST RIGHT OF REFUSAL TO SALVAGE ALL REMOVED ITEMS AND

DEMOLITION AND CONSTRUCTION OPERATIONS.

KSU SHALL DETERMINE THE EXTENTS OF CUTTING AND PATCHING EXISTING INTERIOR FINISHES AS REQUIRED TO PROVIDE NEW ELECTRICAL, PLUMBING, PLUMBING FIXTURES, MECHANICAL, LIGHTING, FIRE ALARM DEVICES, ETC. U.N.O. CUT AND PATCH EXISTING CONSTRUCTION IN A MANNER THAT WILL NOT REDUCE THE BUILDING'S AESTHETIC QUALITIES, OR RESULT IN VISUAL EVIDENCE OF CUTTING AND PATCHING.

### **ARCHITECTURAL:**

A220 BUILDING SECTIONS

- **G001** GENERAL INFORMATION
- **D100** DEMOLITION PLANS A100 NEW CONSTRUCTION PLANS
- A110 FINISH / FURNITURE PLAN & LEGEND
- **A600** DOOR SCHEDULE, ELEVATIONS & DETAILS

### MECHANICAL / ELECTRICAL / PLUMBING:

- **DME100** DEMOLITION MECHANICAL AND ELECTRICAL
- ME100 MECHANICAL AND ELECTRICAL
- **ME101** MECHANICAL AND ELECTRICAL CATWALK
- ME200 ELECTRICAL RISER DIAGRAM
- ME201 DETAILS MECHANICAL AND ELECTRICAL

### SHEET INDEX

# **INFRASTRUCTURE**

COST TO INCLUDE ALL ITEMS ASSOCIATED WITH THE DIMMED AND NON-DIMMED RECEPTACLES AND LIGHTING ETHERNET DEVICES AS NOTED ON ME100 AND ME101. ITEMS TO INCLUDE, BUT NOT LIMITED TO: CONDUIT AND JUNCTION BOXES. CONDUIT IN WALL FROM DEVICES TO ROOM 314 AND ALL PAINTING OF ASSOCIATED CONDUITS. DEVICES SHOWN IN THE STAGE RISERSHALL BE PART OF BASE BID, NOT

COST TO INCLUDE ALL ITEMS ASSOCIATED WITH THE PLYWOOD BACKDROP WALL BEHIND THE STAGE INCLUDING: 3/4" FINISH GRADE PLYWOOD, 2x4 WOOD STUD FRAMING AND PAINT FINISHES.

COST TO INCLUDE ALL ITEMS ASSOCIATED WITH GREEN ROOM 109 INCLUDING: ALL DEMOLITION SCOPE, LVT FLOORING AND RESILIENT BASE, ACOUSTICAL CEILING TILE, ALL PAINT FINISHES, TRACK LIGHTING AND MECHANICAL DIFFUSERS.

DEDUCTIVE ALTERNATE #4: COST TO INSTALL FLOOR MOUNTED FIXED AUDIENCE SEATS IN LIEU OF RISER/ REAR MOUNTED FIXED AUDIENCE SEATS. NOTE: FOR BASE OF RISER/ REAR MOUNTED FIXED AUDIENCE SEATS. NOTE: FOR BASE BID AND ALTERNATE #4, ALL FIXED AUDIENCE SEATING IS OWNER PROVIDED, CONTRACTOR INSTALLED. CONTRACTOR SHALL BE RESPONSIBLE FOR INSTALLATION ONLY.

# KANSAS STATE UNIVERSITY

# **NICHOLS HALL**

# CHAPMAN THEATRE RENOVATION

## MANHATTAN, KANSAS 66506

BUILDING NUMBER: 36700 - 00082

### PROJECT NUMBER: A-013239

KIDS NUMBER: RL24M2X62

KSU / AGENCY NUMBER: 2015-085

# PROJECT DIRECTORY:

### CAMPUS PLANNING AND FACILITIES MANAGEMENT

202 DYKSTRA HALL MANHATTAN, KANSAS 66506-0903 T: 785-532-6377 | F: 785-532-6363

### ARCHITECT:

INTERNATIONAL ARCHITECTS ATELIER 912 BROADWAY BLVD., SUITE 300 KANSAS CITY, MO 64105 T: 816-471-6522 | F: 816-471-3755

### MECHANICAL / ELECTRICAL / PLUMBING ENGINEER: SMITH & BOUCHER, INC.

25501 WEST VALLEY PARKWAY, SUITE 200 OLATHE, KS 66061

T: 913-345-2127 | F: 913-345-0617

## GENERAL DEMOLITION NOTES

# PROJECT TITLE + PROJECT DIRECTORY



Kansas State

UNIVERSITY

CAMPUS PLANNING &

912 BROADWAY BLVD, SUITE 300

P:816 471 6522 | F:816.471.3755 | W: I-A-A.COM

smith&boucher

5501 WEST VALLEY PARKWAY, SUITE 300

DR 2015-085

TOTAL SHEETS IN SET

**12** 

of **12** 

P:913 345 2127 | F: 913 345 0617

SMITH & BOUCHER PROJECT NUMBER: 1616800

OLATHE, KS 66061

KSU DWG NO.

SHEET

FACILITIES MANAGEMENT


MAJID AMIRAHMADI, KANSAS REGISTERED ARCHITECT, DO HEREBY ACCEPT PROFESSIONA RESPONSIBILITY FOR THE ATTACHED ARCHITECTURAL DRAWINGS. I HEREBY DISCLAIM ANY RESPONSIBILITY FOR ALL OTHER DRAWINGS INCLUDED IN THIS SET OF CONSTRUCTION DOCUMENTS, THEY BEING THE RESPONSIBILITY OF OTHER PROFESSIONALS.



MAJID AMIRAHMADI, AIA INTERNATIONAL ARCHITECTS ATELIER

# PROFESSIONAL DISCLAIMER

I, CHRISTOPHER ALBRIGHT, KANSAS REGISTERED ENGINEER, DO HEREBY ACCEPT PROFESSIONAL RESPONSIBILITY FOR THE ATTACHED MECHANICAL, ELECTRICAL, PLUMBING, AND FIRE ALARM DRAWINGS. I HEREBY DISCLAIM ANY RESPONSIBILITY FOR ALL OTHER DRAWINGS INCLUDED IN THIS SET OF CONSTRUCTION DOCUMENTS, THEY BEING THE RESPONSIBILITY OF OTHER PROFESSIONALS.

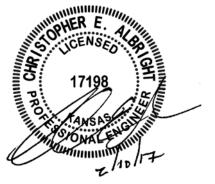

CHRISTOPHER ALBRIGHT, P.E. SMITH & BOUCHER, INC.

# PROFESSIONAL DISCLAIMER | A2



Calvin Hall McCain **KSU Student Union Auditorium Parking Garage** 

**PROJECT LOCATION** 

**CHAPMAN THEATRE** 

**Anderson Avenue** 


PROJECT LOCATION

**INFORMATION** A-013239

**GENERAL** 

ORIGINIAL CONSTRUCTION DOCUMENTS

G001

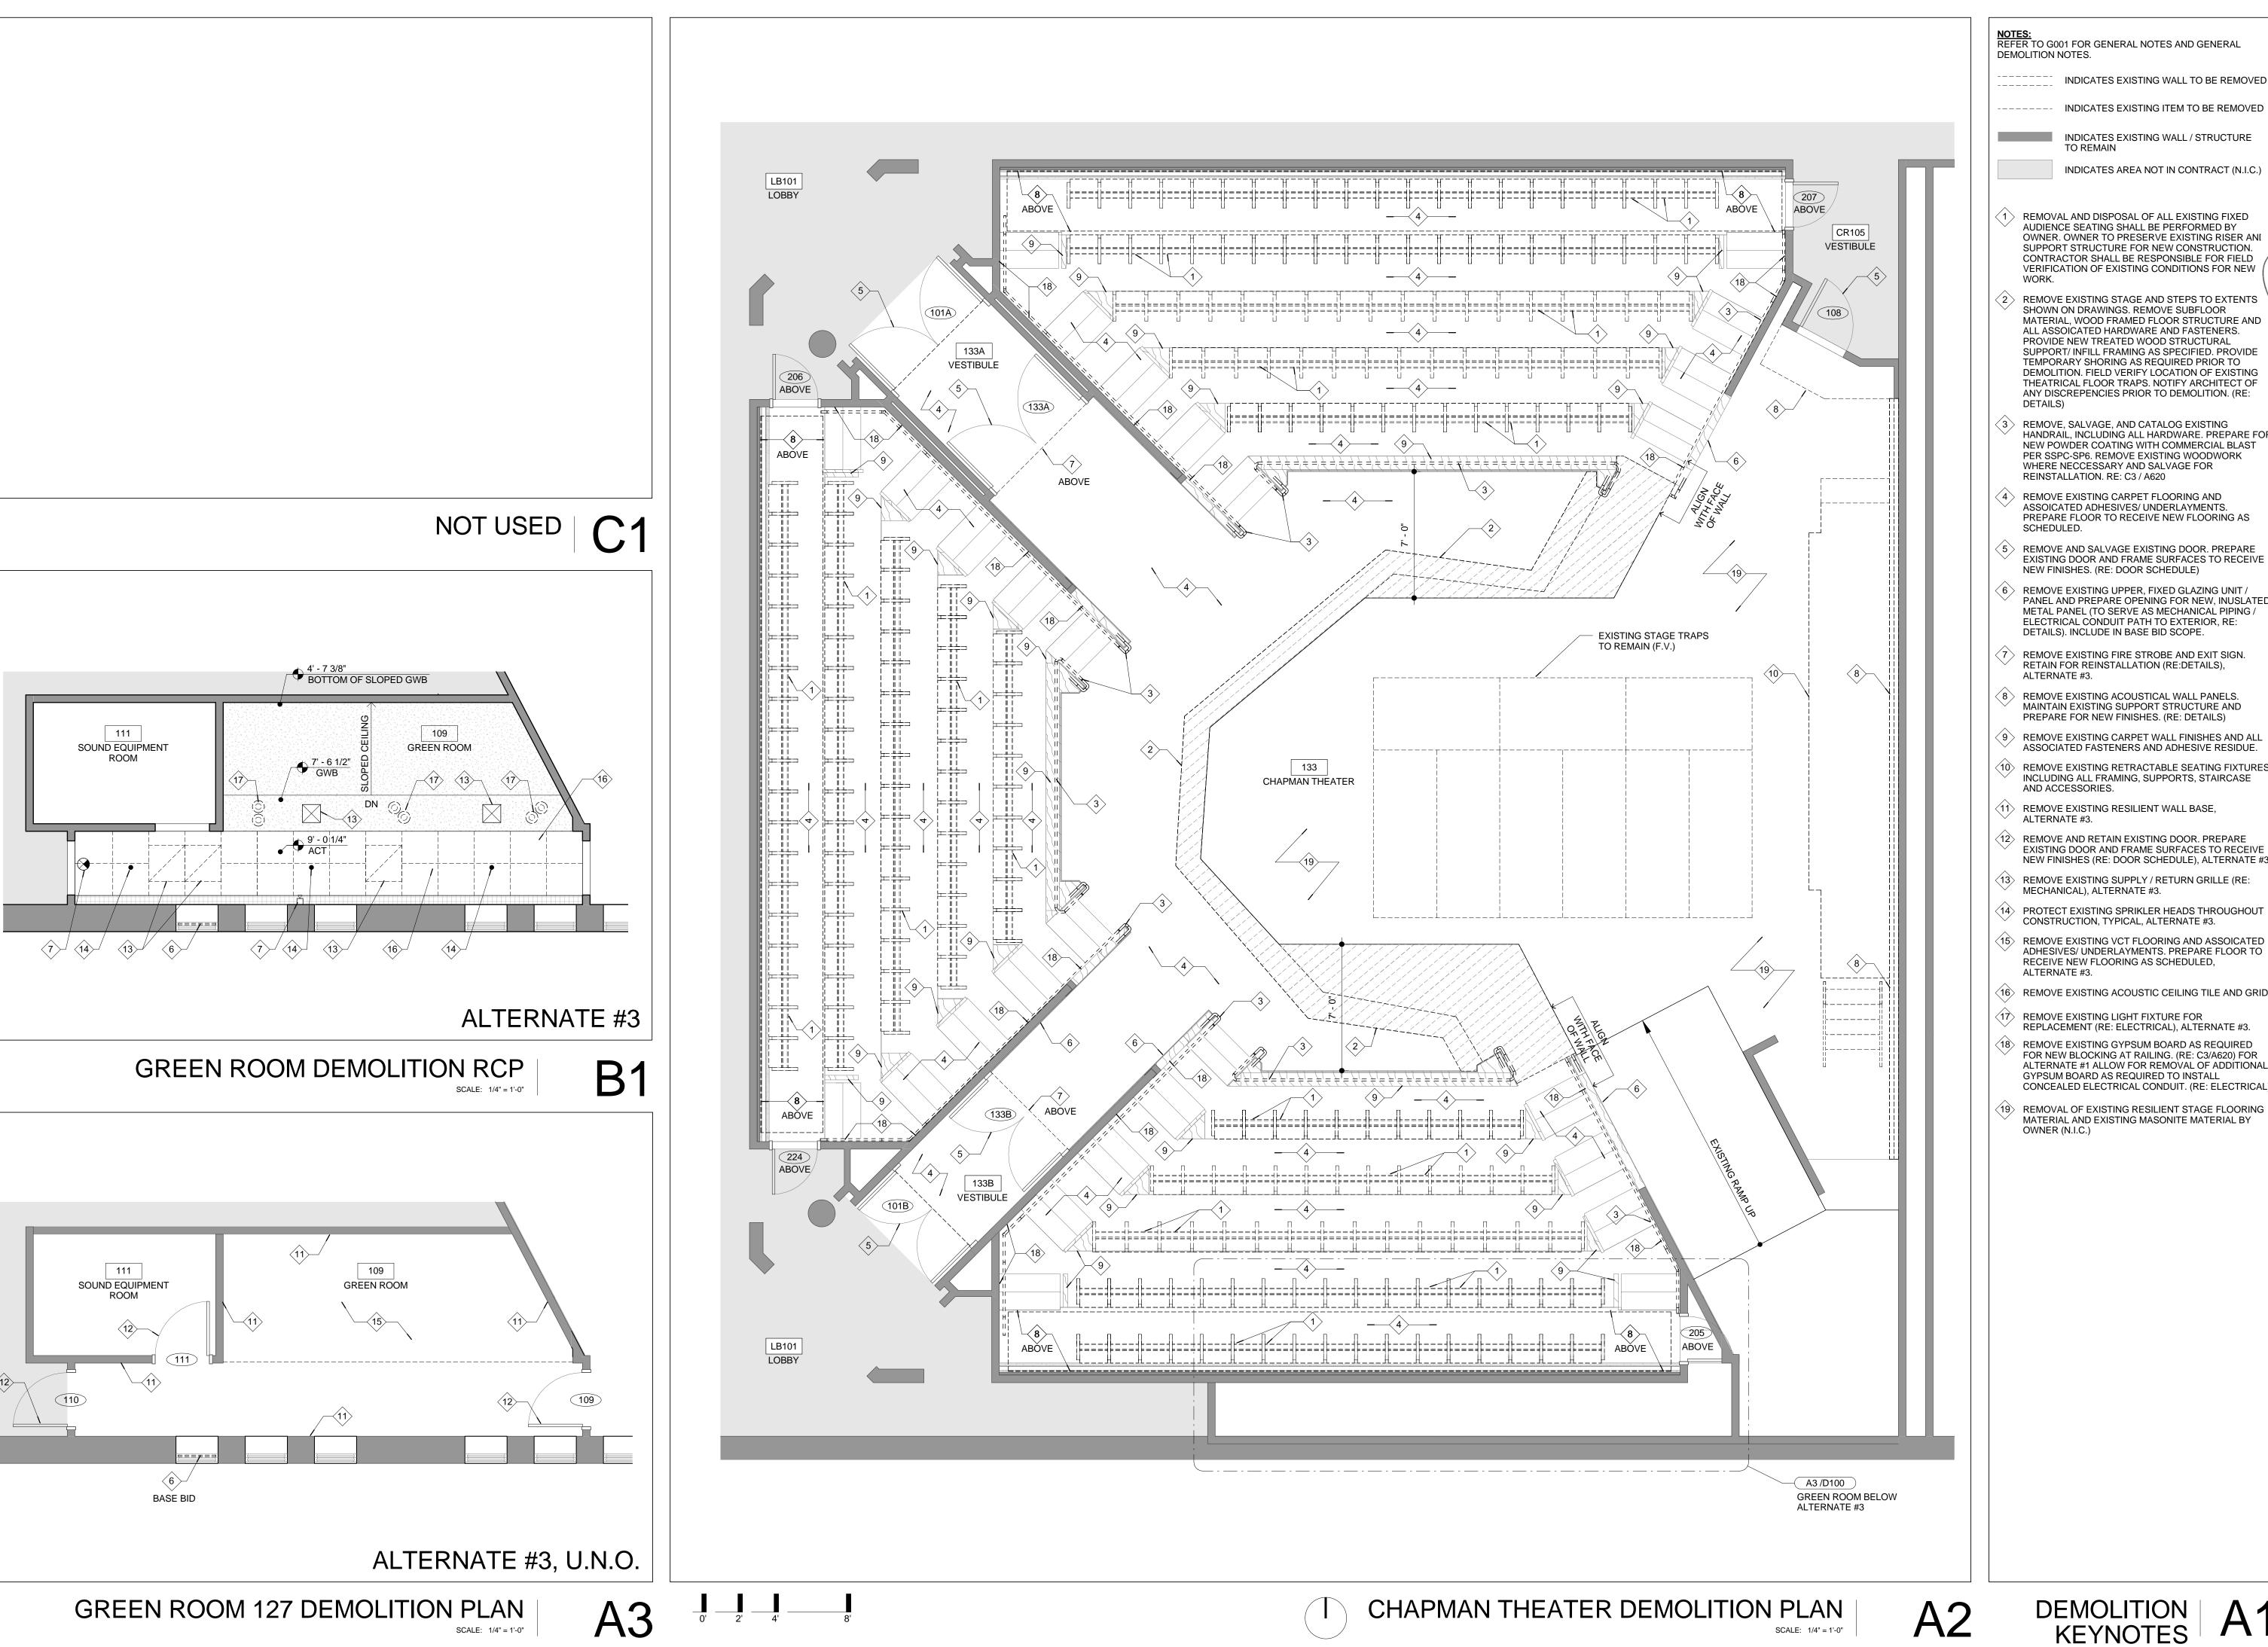

NOTES: REFER TO G001 FOR GENERAL NOTES AND GENERAL

INDICATES EXISTING WALL TO BE REMOVED

INDICATES EXISTING WALL / STRUCTURE

REMOVAL AND DISPOSAL OF ALL EXISTING FIXED AUDIENCE SEATING SHALL BE PERFORMED BY OWNER. OWNER TO PRESERVE EXISTING RISER ANI SUPPORT STRUCTURE FOR NEW CONSTRUCTION. CONTRACTOR SHALL BE RESPONSIBLE FOR FIELD VERIFICATION OF EXISTING CONDITIONS FOR NEW

REMOVE EXISTING STAGE AND STEPS TO EXTENTS SHOWN ON DRAWINGS. REMOVE SUBFLOOR MATERIAL, WOOD FRAMED FLOOR STRUCTURE AND ALL ASSOICATED HARDWARE AND FASTENERS. PROVIDE NEW TREATED WOOD STRUCTURAL SUPPORT/ INFILL FRAMING AS SPECIFIED. PROVIDE TEMPORARY SHORING AS REQUIRED PRIOR TO DEMOLITION. FIELD VERIFY LOCATION OF EXISTING THEATRICAL FLOOR TRAPS. NOTIFY ARCHITECT OF ANY DISCREPENCIES PRIOR TO DEMOLITION. (RE:

REMOVE, SALVAGE, AND CATALOG EXISTING HANDRAIL, INCLUDING ALL HARDWARE. PREPARE FOR NEW POWDER COATING WITH COMMERCIAL BLAST PER SSPC-SP6. REMOVE EXISTING WOODWORK WHERE NECCESSARY AND SALVAGE FOR REINSTALLATION. RE: C3 / A620

REMOVE EXISTING CARPET FLOORING AND ASSOICATED ADHESIVES/ UNDERLAYMENTS. PREPARE FLOOR TO RECEIVE NEW FLOORING AS

REMOVE AND SALVAGE EXISTING DOOR. PREPARE EXISTING DOOR AND FRAME SURFACES TO RECEIVE

REMOVE EXISTING UPPER, FIXED GLAZING UNIT / PANEL AND PREPARE OPENING FOR NEW, INUSLATED METAL PANEL (TO SERVE AS MECHANICAL PIPING / ELECTRICAL CONDUIT PATH TO EXTERIOR, RE: DETAILS). INCLUDE IN BASE BID SCOPE.

REMOVE EXISTING FIRE STROBE AND EXIT SIGN. RETAIN FOR REINSTALLATION (RE:DETAILS),

MAINTAIN EXISTING SUPPORT STRUCTURE AND PREPARE FOR NEW FINISHES. (RE: DETAILS) 9 REMOVE EXISTING CARPET WALL FINISHES AND ALL

ASSOCIATED FASTENERS AND ADHESIVE RESIDUE.

10> REMOVE EXISTING RETRACTABLE SEATING FIXTURES INCLUDING ALL FRAMING, SUPPORTS, STAIRCASE AND ACCESSORIES.

(11) REMOVE EXISTING RESILIENT WALL BASE,

12> REMOVE AND RETAIN EXISTING DOOR. PREPARE EXISTING DOOR AND FRAME SURFACES TO RECEIVE

REMOVE EXISTING SUPPLY / RETURN GRILLE (RE: MECHANICAL), ALTERNATE #3.

PROTECT EXISTING SPRIKLER HEADS THROUGHOUT

REMOVE EXISTING VCT FLOORING AND ASSOICATED ADHESIVES/ UNDERLAYMENTS. PREPARE FLOOR TO RECEIVE NEW FLOORING AS SCHEDULED,

(16) REMOVE EXISTING ACOUSTIC CEILING TILE AND GRID.

REMOVE EXISTING LIGHT FIXTURE FOR

REPLACEMENT (RE: ELECTRICAL), ALTERNATE #3. 18 REMOVE EXISTING GYPSUM BOARD AS REQUIRED FOR NEW BLOCKING AT RAILING. (RE: C3/A620) FOR GYPSUM BOARD AS REQUIRED TO INSTALL

REMOVAL OF EXISTING RESILIENT STAGE FLOORING MATERIAL AND EXISTING MASONITE MATERIAL BY

Kansas State UNIVERSITY

> CAMPUS PLANNING & FACILITIES MANAGEMENT

RNATIONAL ARCHITECTS ATELIER

912 BROADWAY BLVD, SUITE 300 KANSAS CITY, MO 64105 p:816 471 6522 | p:816.471.3755 | w:I-A-A.COM CANSAS STATE CERTIFICATE OF AUTHORITY #000582

smith&boucher 5501 WEST VALLEY PARKWAY, SUITE 300 OLATHE, KS 66061 P:913 345 2127 | F: 913 345 0617

SMITH & BOUCHER PROJECT NUMBER: 1616800

KSU DWG NO.

DR 2015-085

**2** of **12** 


TOTAL SHEETS IN SET


**DEMOLITION PLANS** 

A-013239


D100

DEMOLITION KEYNOTES

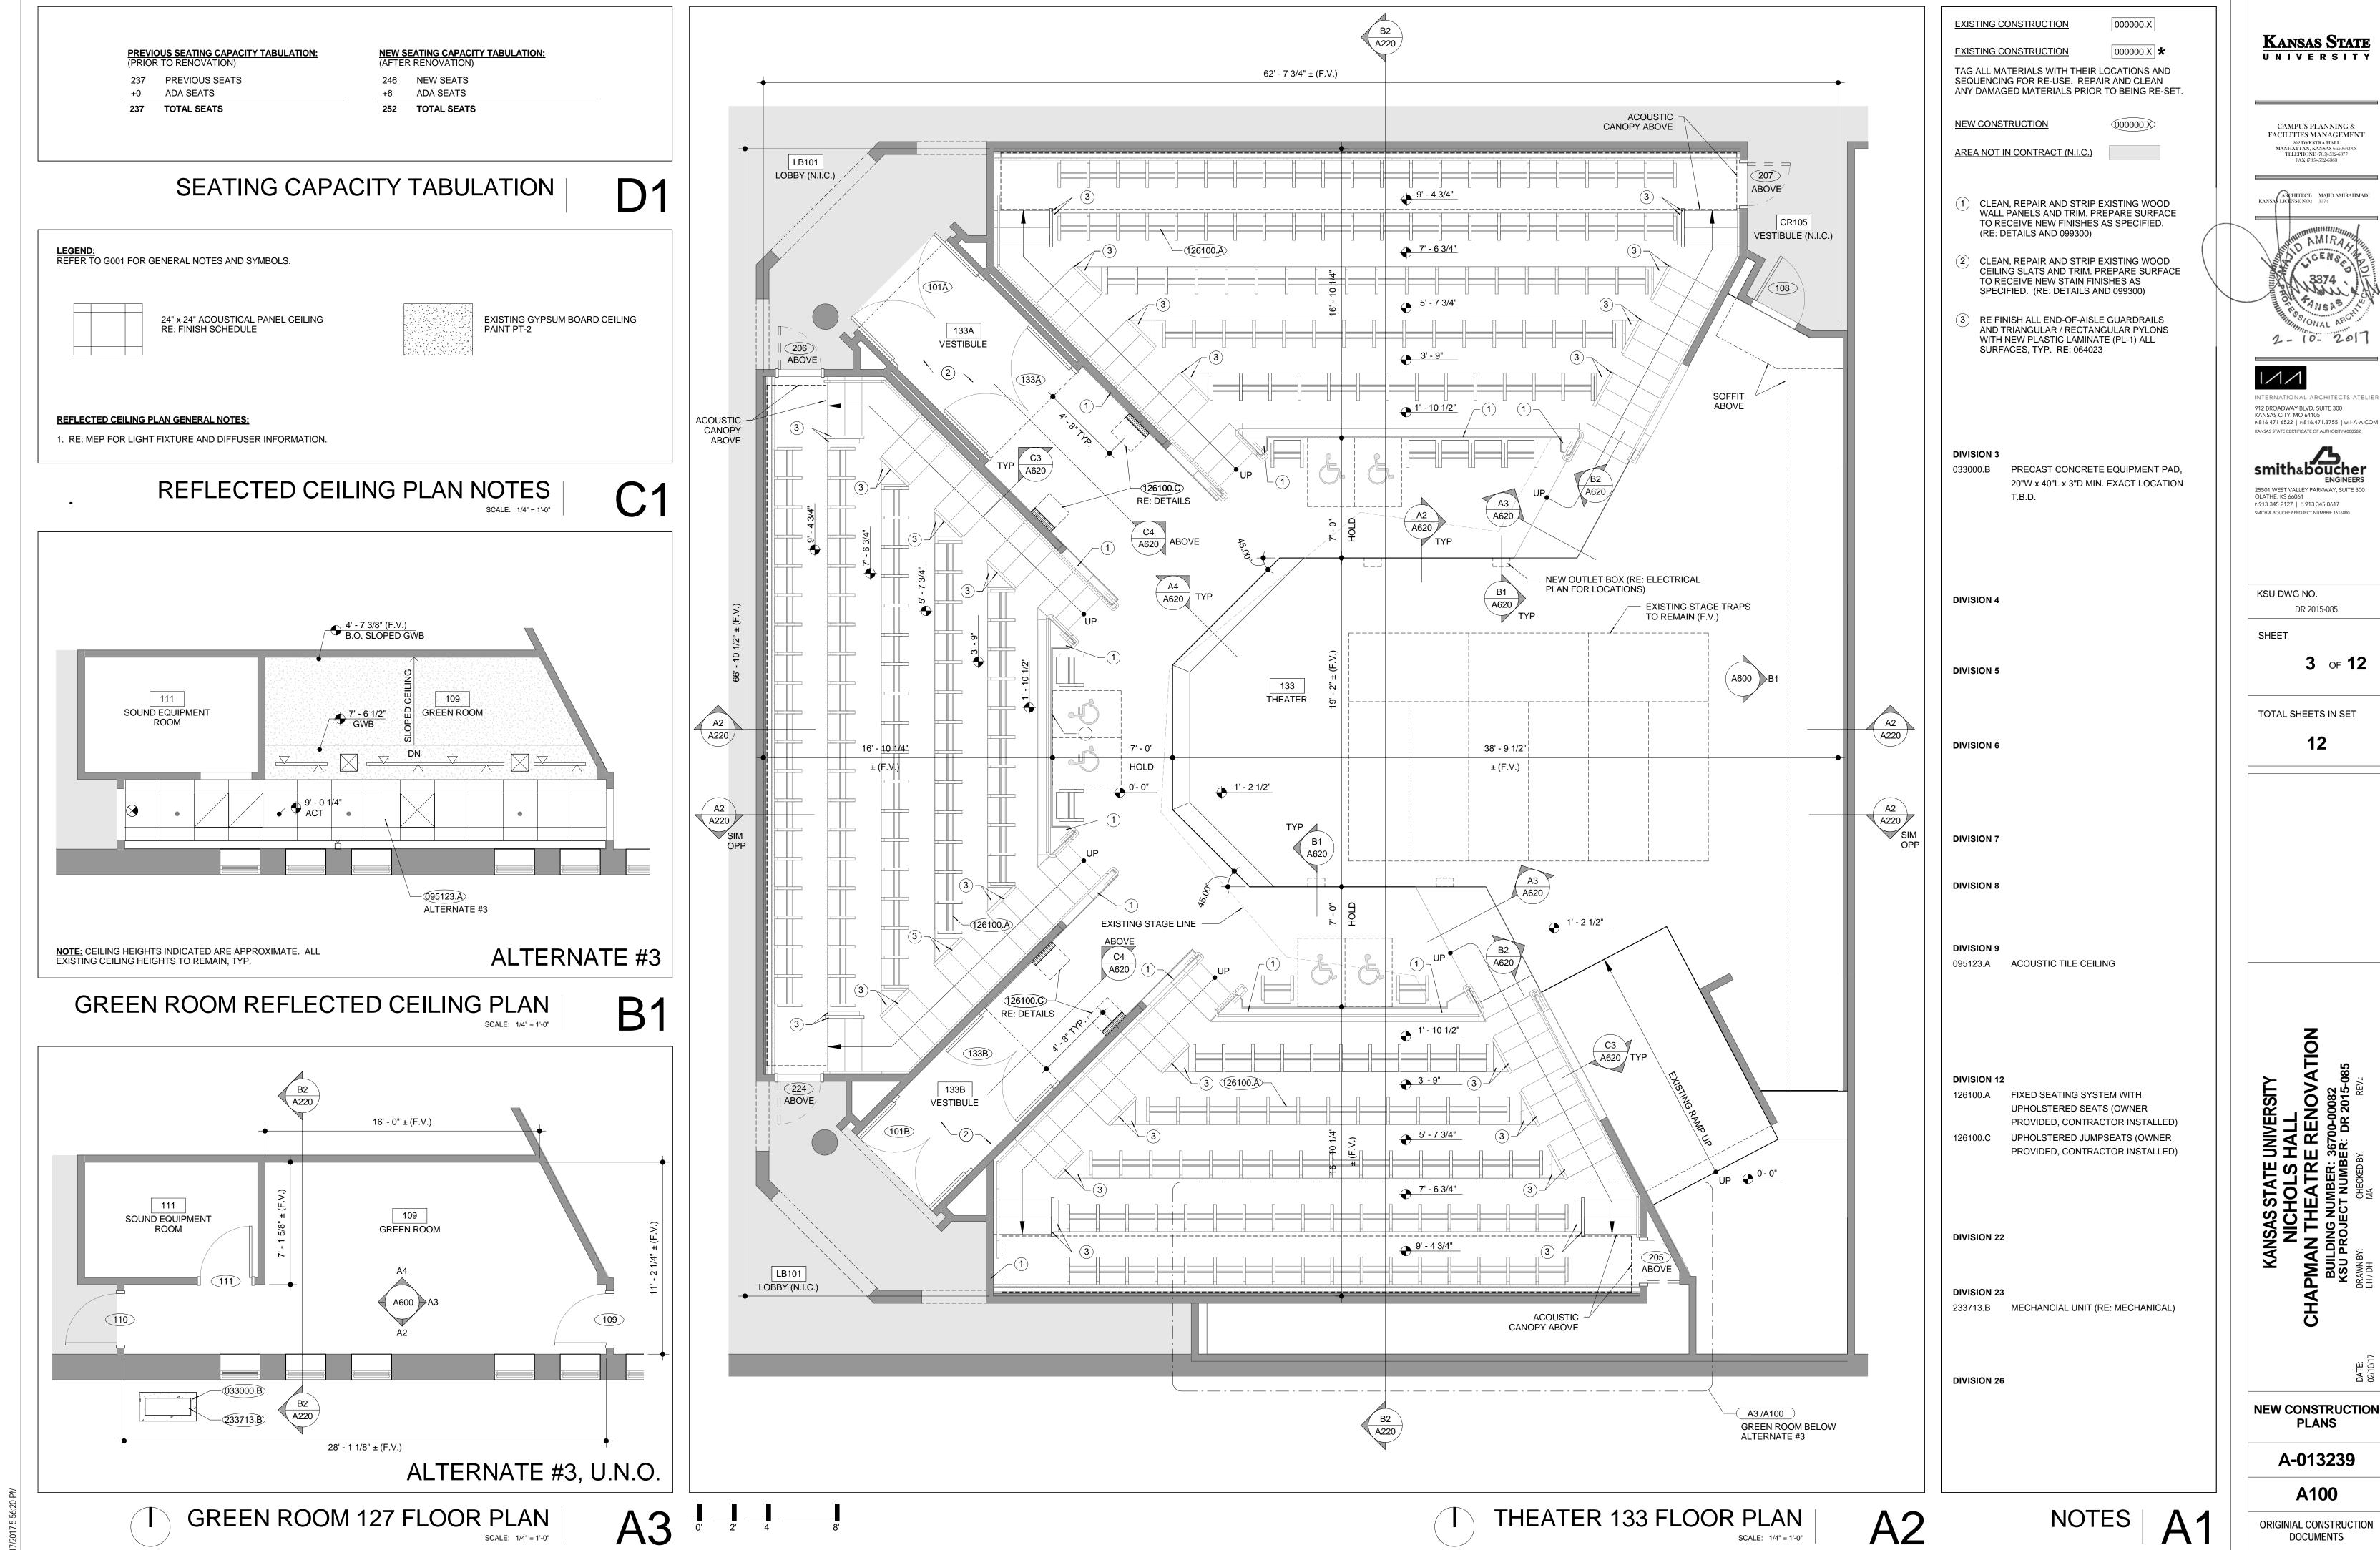


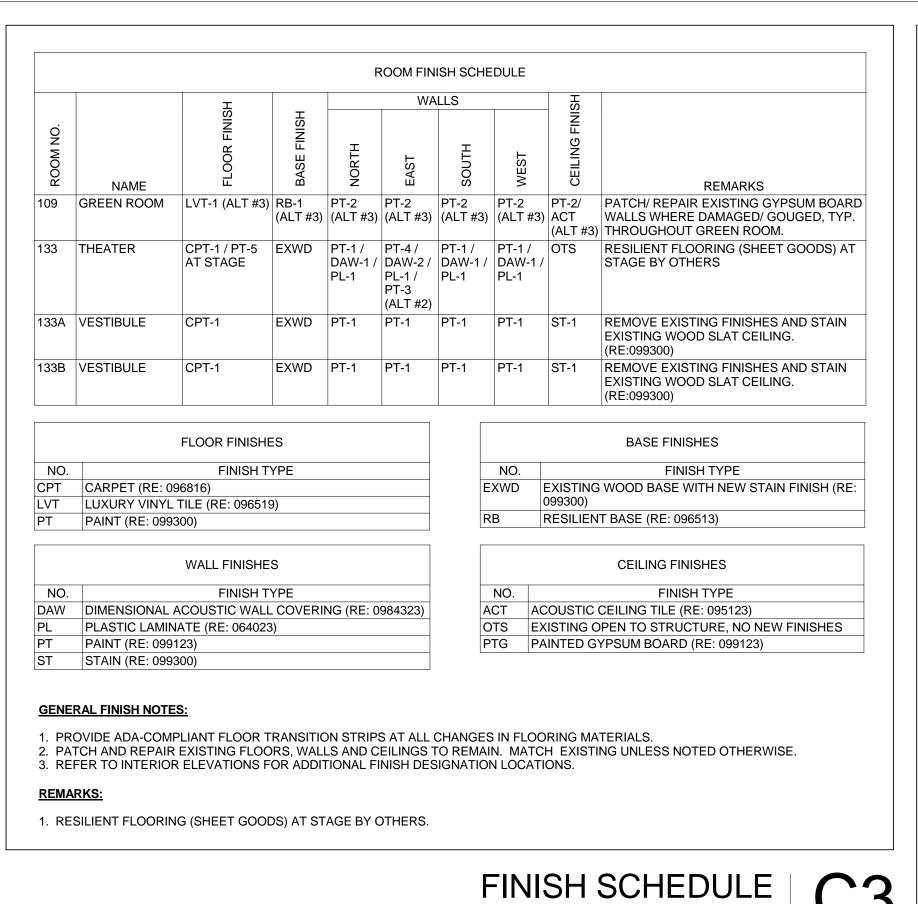


# FINISH SCHEDULE C3

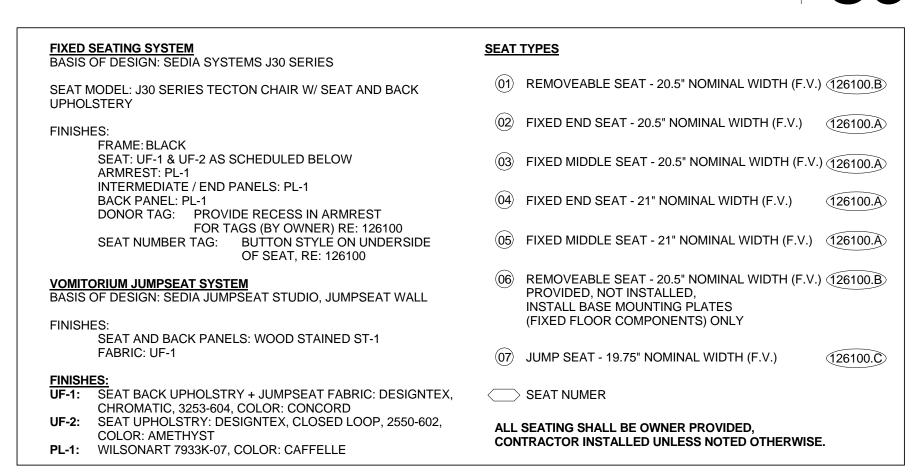

# FURNITURE LEGEND

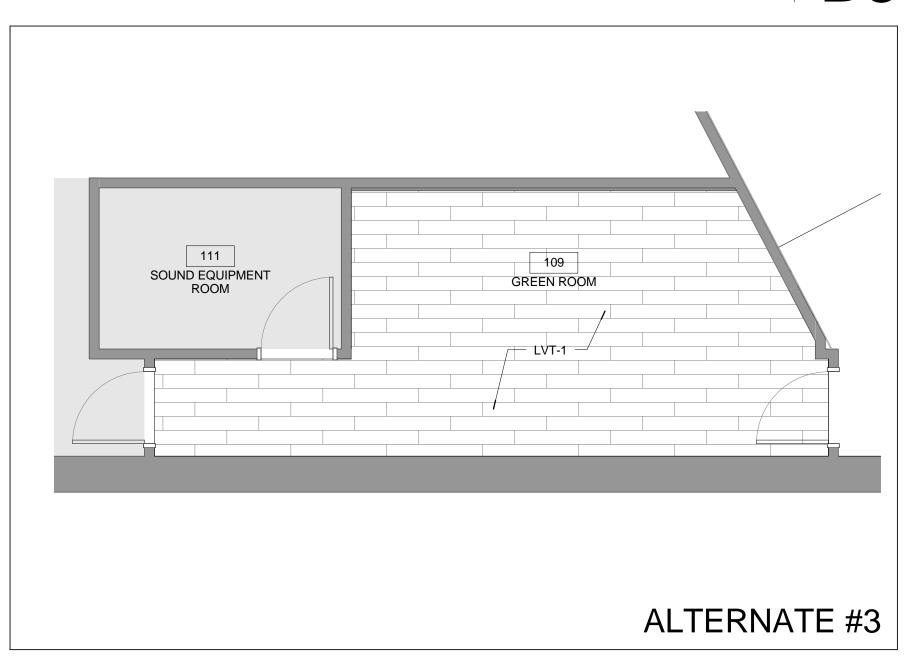

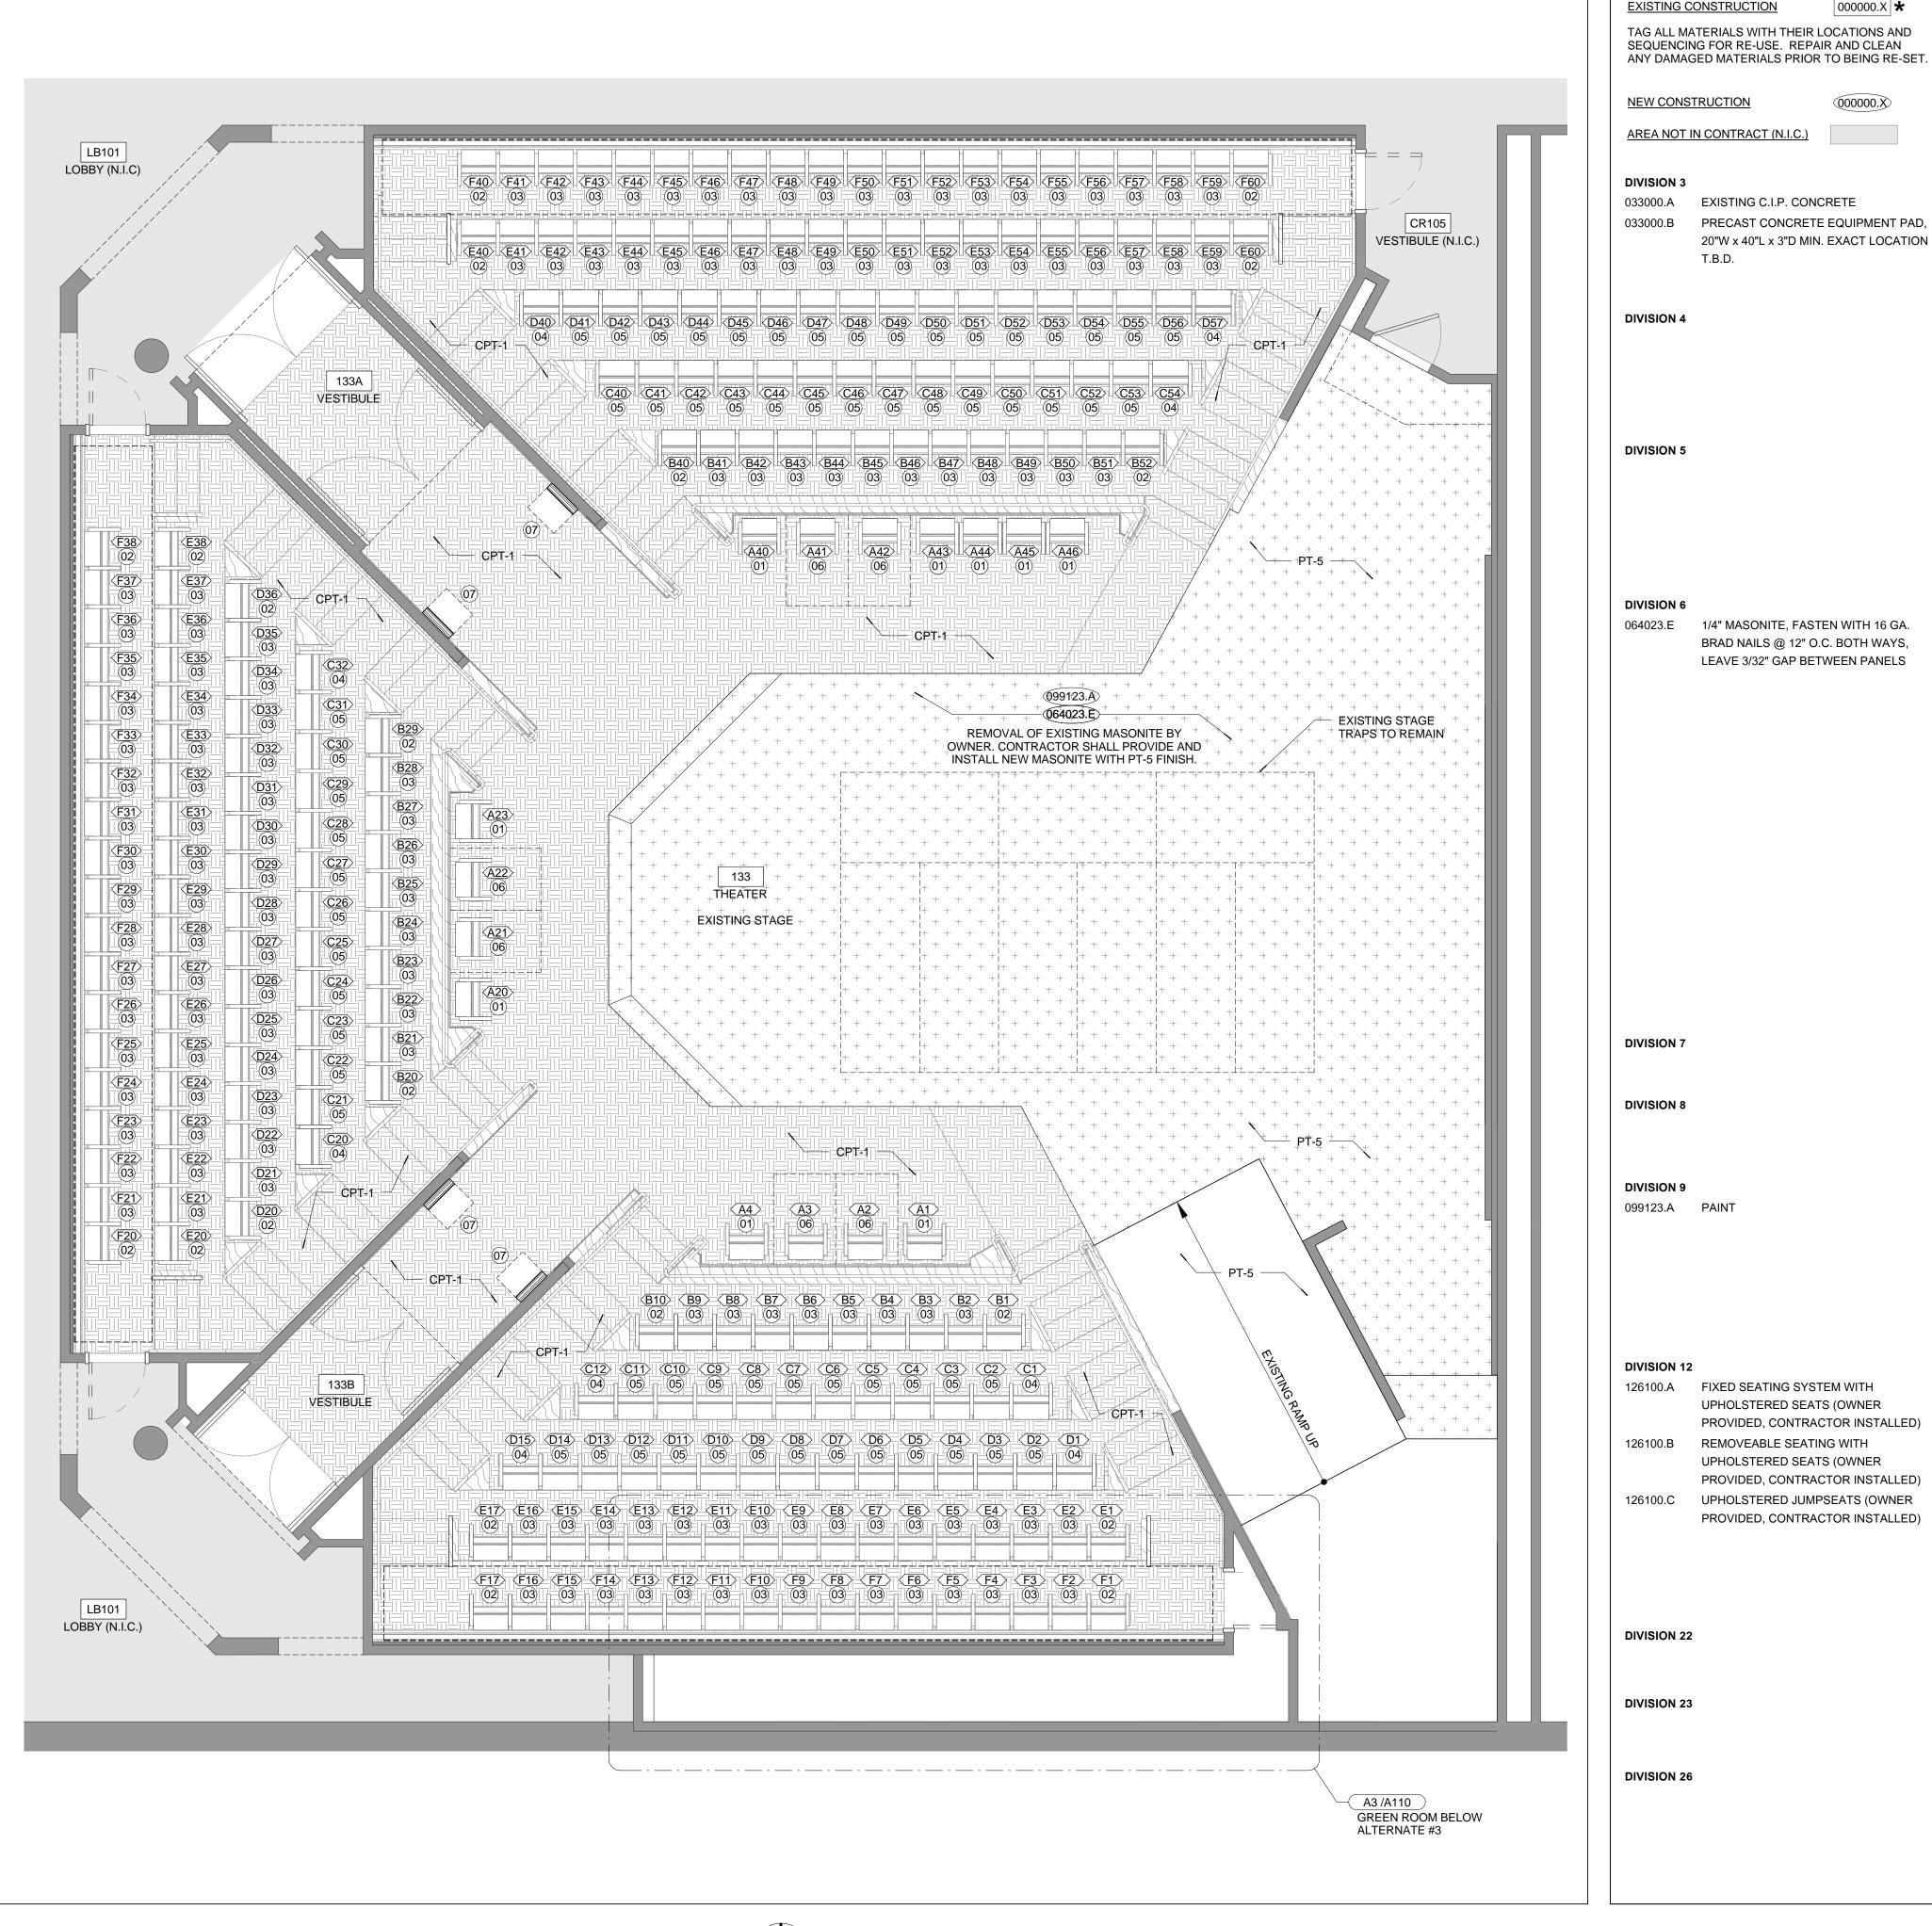

Kansas State UNIVERSITY

CAMPUS PLANNING & FACILITIES MANAGEMENT

912 BROADWAY BLVD, SUITE 300 P:816 471 6522 | F:816.471.3755 | W: I-A-A.COM

OLATHE, KS 66061 P:913 345 2127 | F: 913 345 0617

SMITH & BOUCHER PROJECT NUMBER: 1616800

KSU DWG NO.

DR 2015-085

SHEET

4 of 12

TOTAL SHEETS IN SET

126100.A FIXED SEATING SYSTEM WITH UPHOLSTERED SEATS (OWNER PROVIDED, CONTRACTOR INSTALLED) 126100.B REMOVEABLE SEATING WITH

**EXISTING CONSTRUCTION** 

000000.X

000000.X 🖈

(000000.X)

PROVIDED, CONTRACTOR INSTALLED) UPHOLSTERED JUMPSEATS (OWNER PROVIDED, CONTRACTOR INSTALLED)


> FINISH / FURNITURE **PLAN & LEGEND**


> > A-013239


KANSAS STATE UNIVERSITY NICHOLS HALL MAN THEATRE RENOVA


A110

**ORIGINIAL CONSTRUCTION** DOCUMENTS

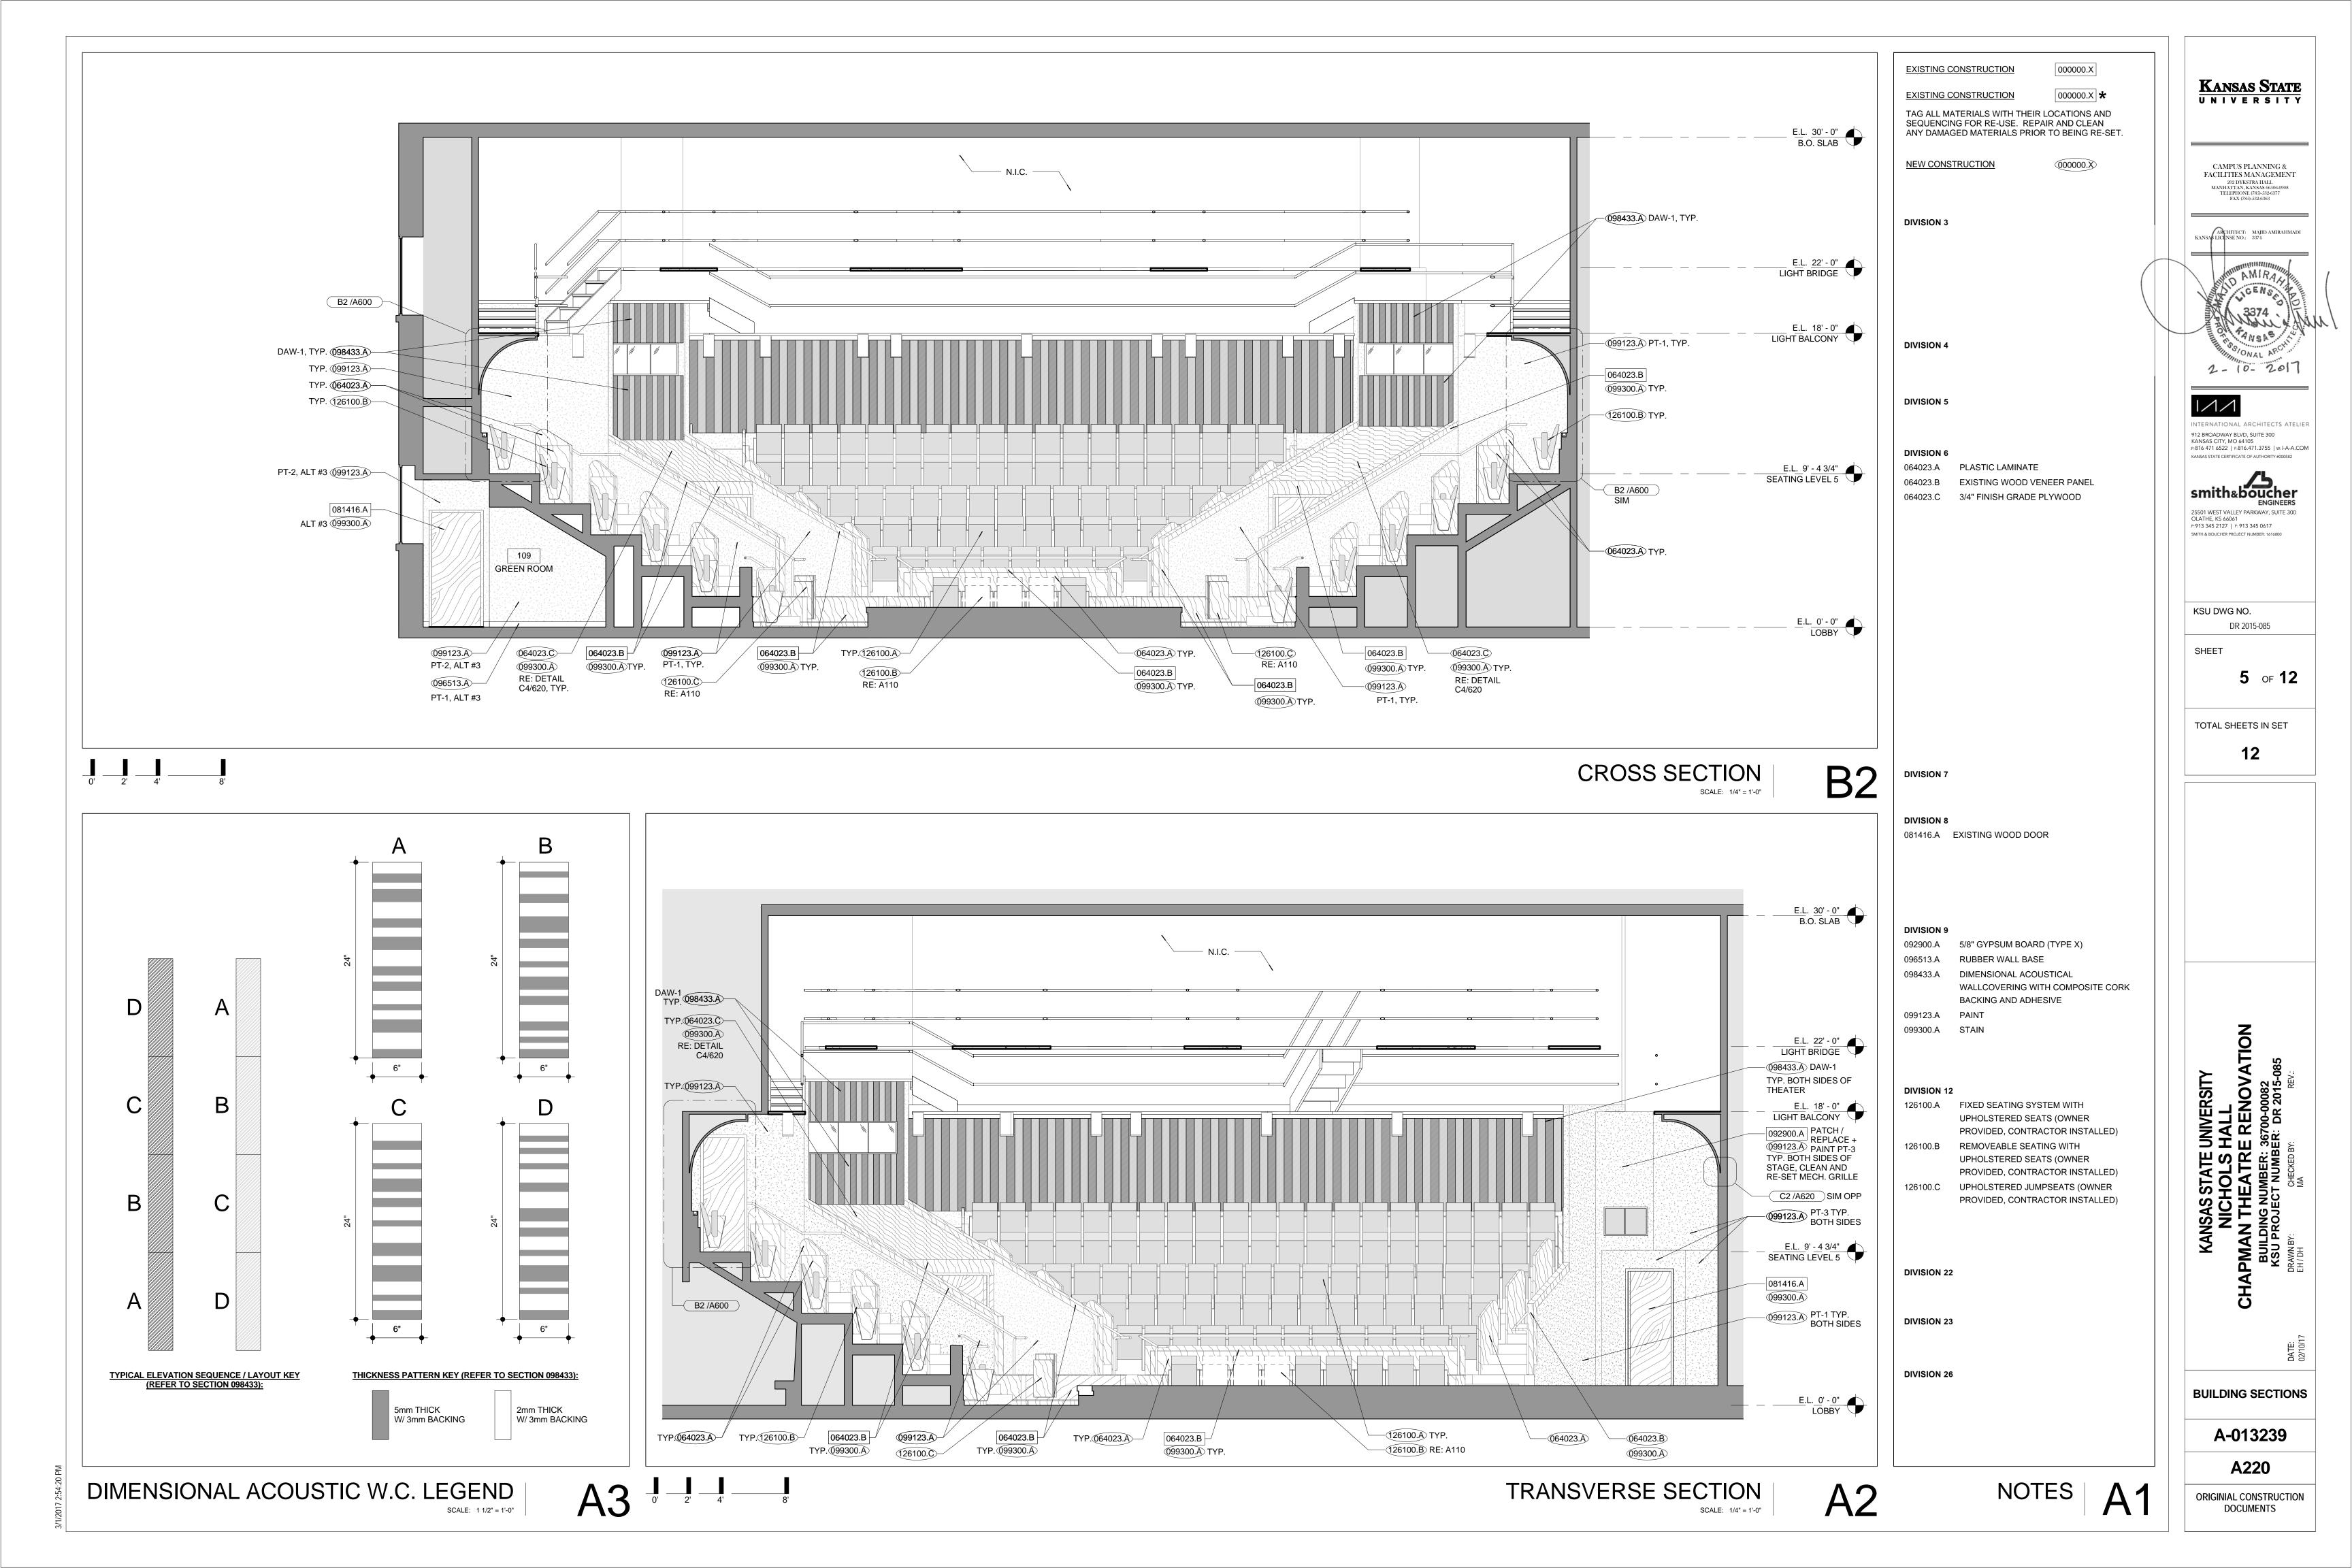

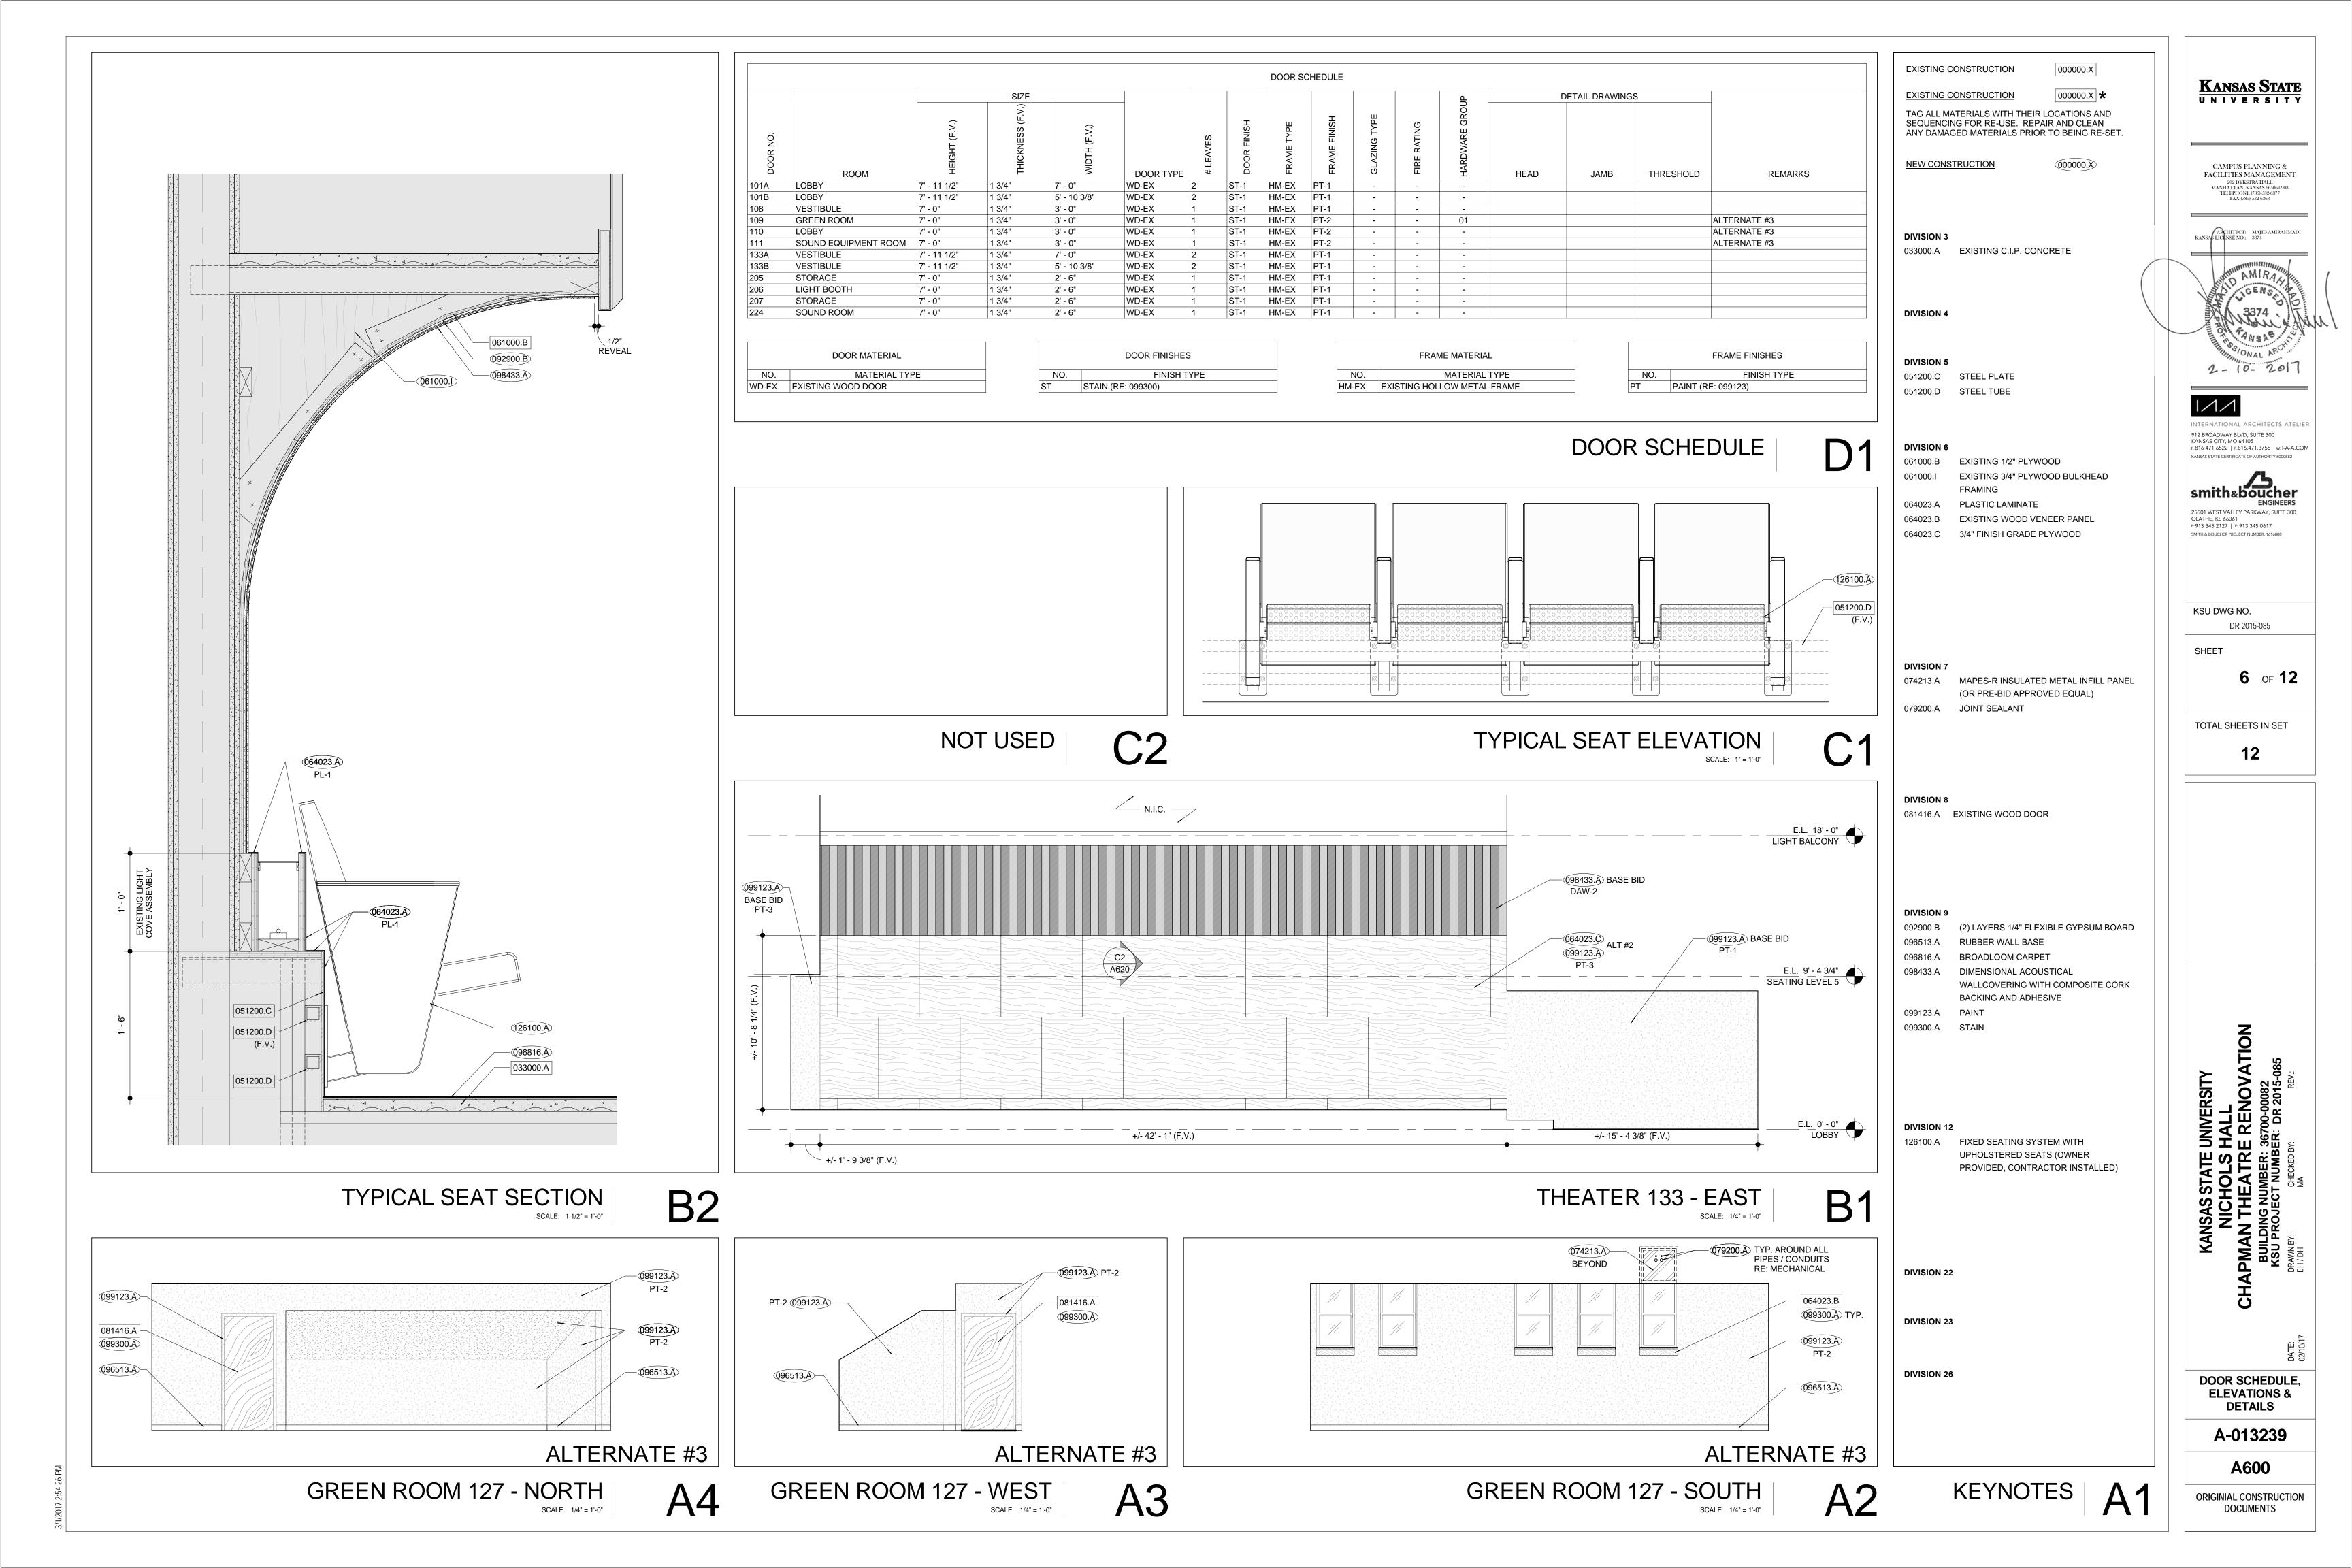


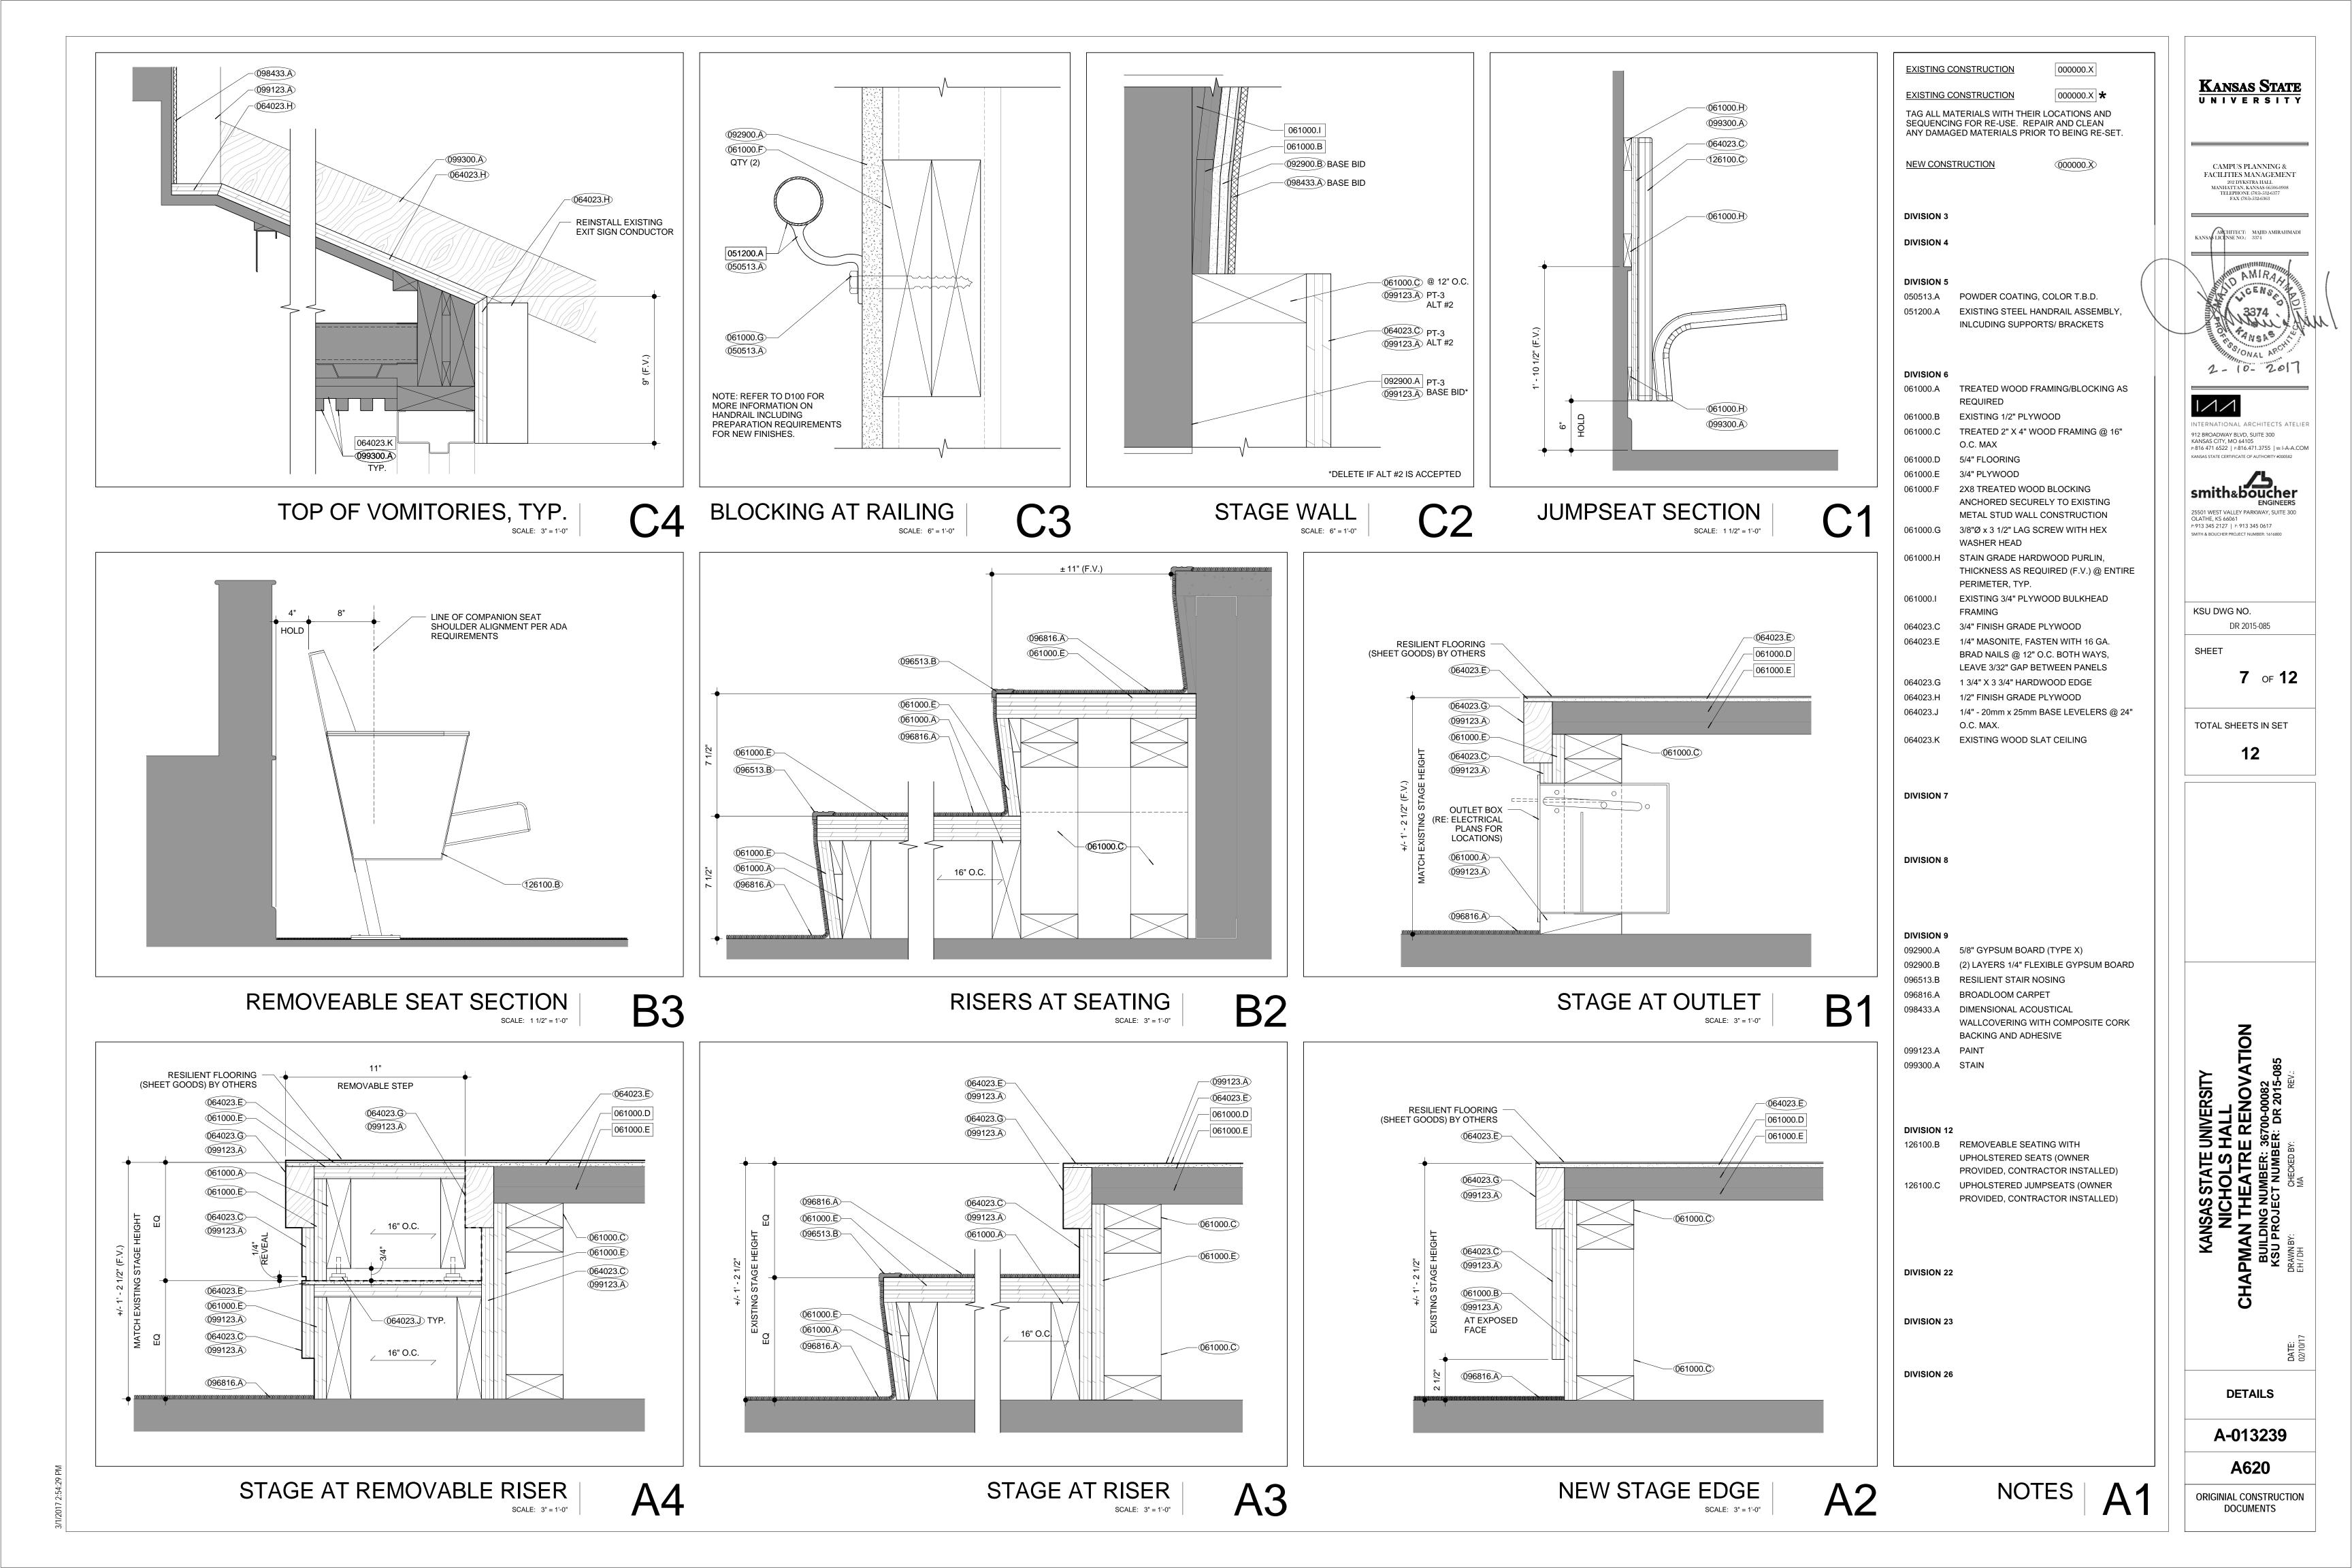

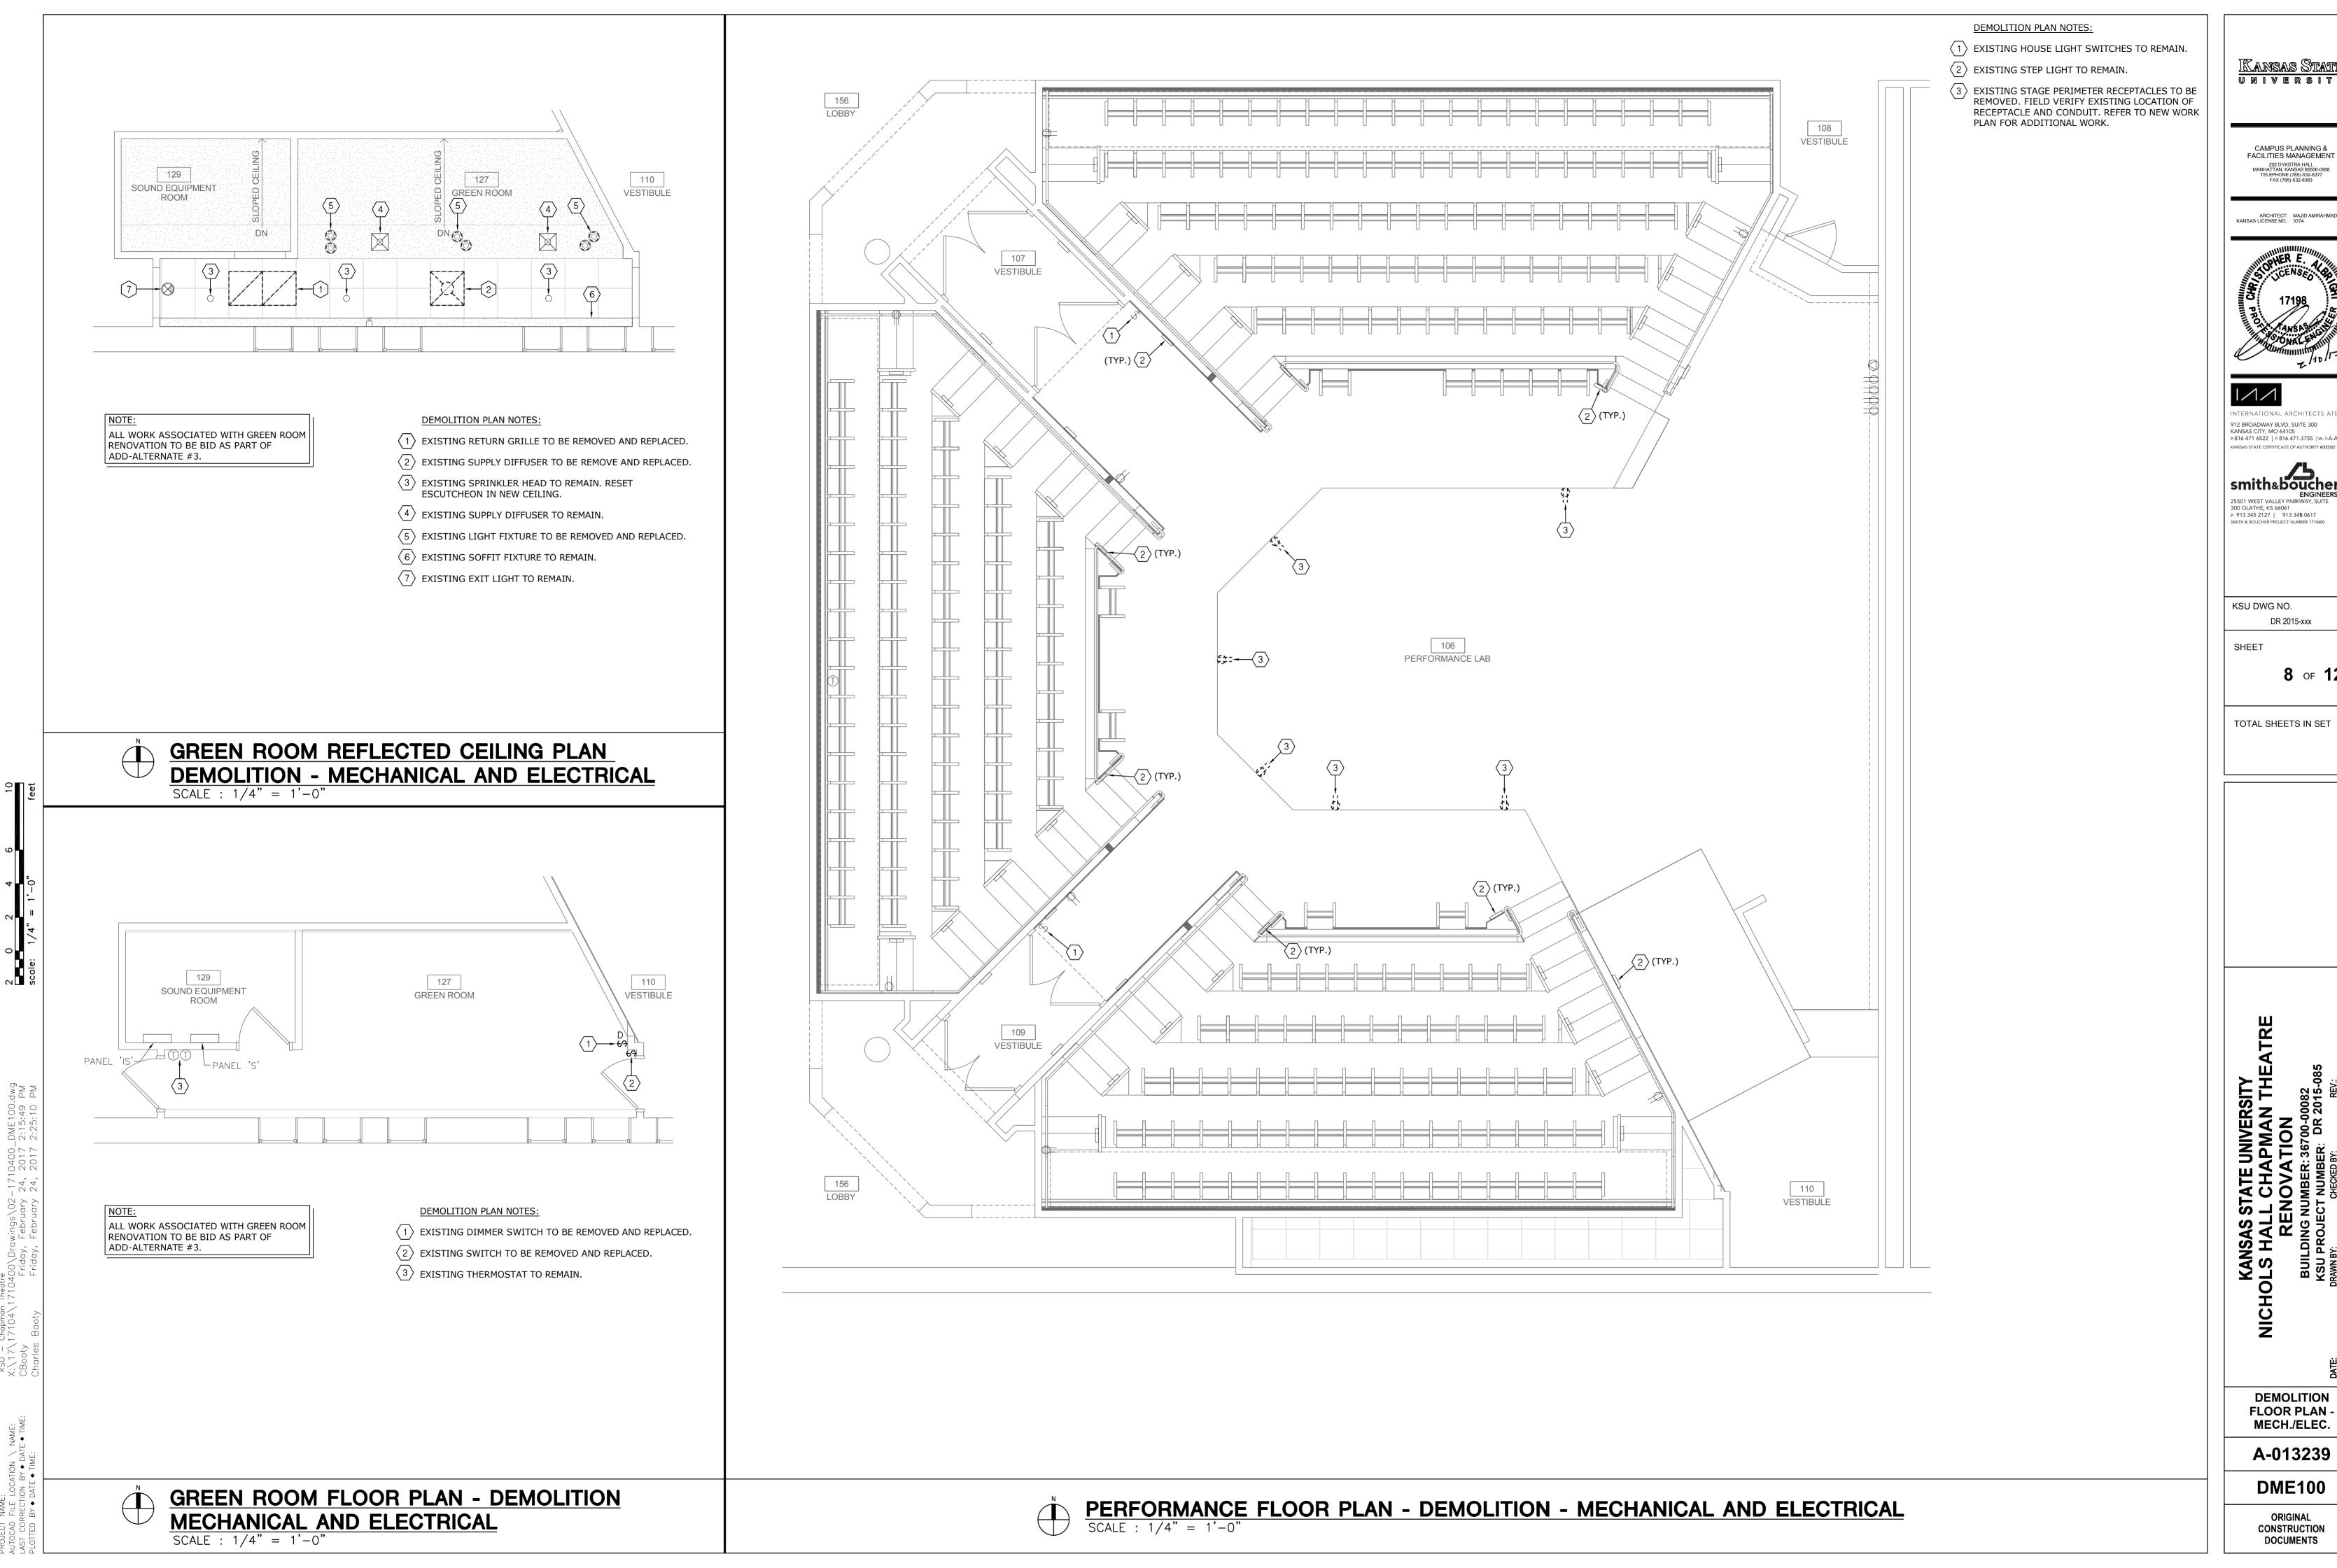

<u>IKansas Statte</u> university

CAMPUS PLANNING & FACILITIES MANAGEMENT

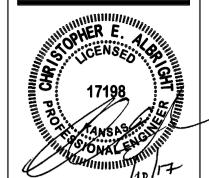

912 BROADWAY BLVD, SUITE 300 KANSAS CITY, MO 64105 p:816 471 6522 | p:816.471.3755 | w: I-A-A.COM




8 of 12

A-013239

**DME100** 

ORIGINAL CONSTRUCTION **DOCUMENTS** 

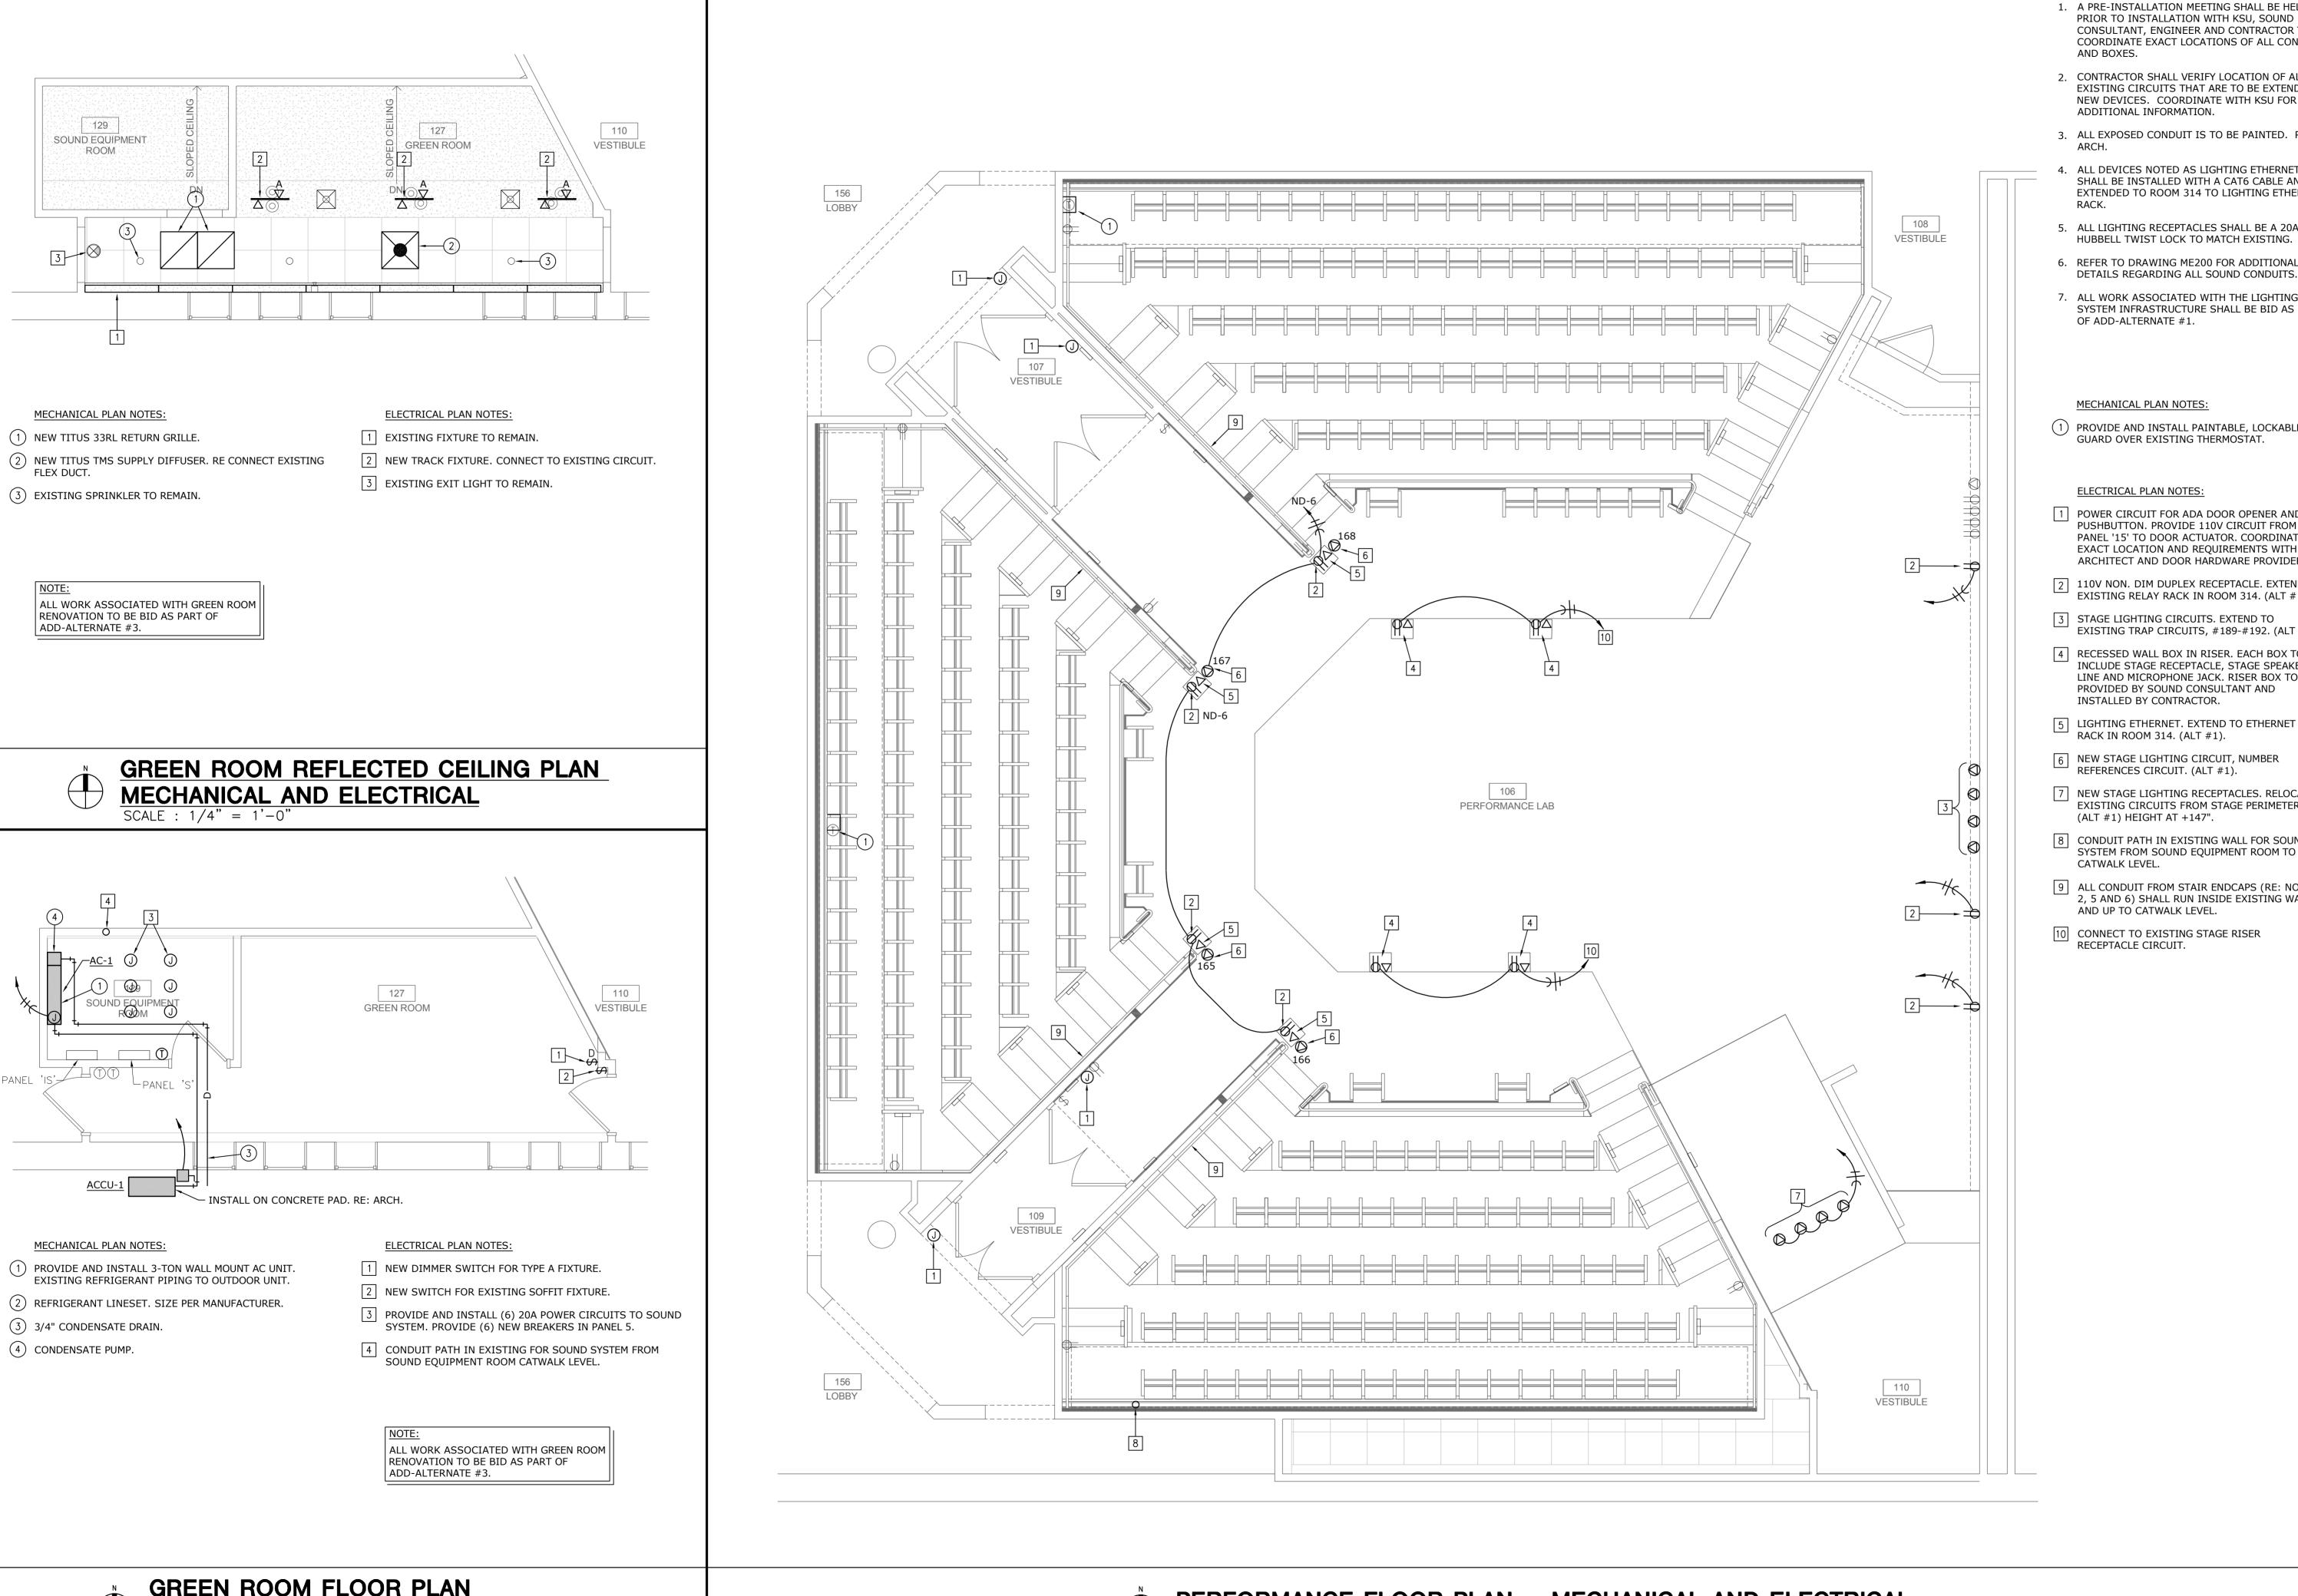

**GENERAL NOTES:** 

1. A PRE-INSTALLATION MEETING SHALL BE HELD PRIOR TO INSTALLATION WITH KSU, SOUND CONSULTANT, ENGINEER AND CONTRACTOR TO COORDINATE EXACT LOCATIONS OF ALL CONDUIT AND BOXES.

2. CONTRACTOR SHALL VERIFY LOCATION OF ALL EXISTING CIRCUITS THAT ARE TO BE EXTENDED TO NEW DEVICES. COORDINATE WITH KSU FOR

3. ALL EXPOSED CONDUIT IS TO BE PAINTED. RE:

4. ALL DEVICES NOTED AS LIGHTING ETHERNET SHALL BE INSTALLED WITH A CAT6 CABLE AND EXTENDED TO ROOM 314 TO LIGHTING ETHERNET

5. ALL LIGHTING RECEPTACLES SHALL BE A 20A, HUBBELL TWIST LOCK TO MATCH EXISTING.

6. REFER TO DRAWING ME200 FOR ADDITIONAL

7. ALL WORK ASSOCIATED WITH THE LIGHTING SYSTEM INFRASTRUCTURE SHALL BE BID AS PART OF ADD-ALTERNATE #1.

MECHANICAL PLAN NOTES:

1 PROVIDE AND INSTALL PAINTABLE, LOCKABLE GUARD OVER EXISTING THERMOSTAT.

**ELECTRICAL PLAN NOTES:** 

1 POWER CIRCUIT FOR ADA DOOR OPENER AND PUSHBUTTON. PROVIDE 110V CIRCUIT FROM PANEL '15' TO DOOR ACTUATOR. COORDINATE EXACT LOCATION AND REQUIREMENTS WITH ARCHITECT AND DOOR HARDWARE PROVIDER.

2 110V NON. DIM DUPLEX RECEPTACLE. EXTEND TO EXISTING RELAY RACK IN ROOM 314. (ALT #1).

3 STAGE LIGHTING CIRCUITS. EXTEND TO

EXISTING TRAP CIRCUITS, #189-#192. (ALT #1).

4 RECESSED WALL BOX IN RISER. EACH BOX TO INCLUDE STAGE RECEPTACLE, STAGE SPEAKER LINE AND MICROPHONE JACK. RISER BOX TO BE PROVIDED BY SOUND CONSULTANT AND INSTALLED BY CONTRACTOR.

5 LIGHTING ETHERNET. EXTEND TO ETHERNET RACK IN ROOM 314. (ALT #1).

6 NEW STAGE LIGHTING CIRCUIT, NUMBER REFERENCES CIRCUIT. (ALT #1).


7 NEW STAGE LIGHTING RECEPTACLES. RELOCATE EXISTING CIRCUITS FROM STAGE PERIMETER. (ALT #1) HEIGHT AT +147".

8 CONDUIT PATH IN EXISTING WALL FOR SOUND SYSTEM FROM SOUND EQUIPMENT ROOM TO CATWALK LEVEL.

9 ALL CONDUIT FROM STAIR ENDCAPS (RE: NOTES 2, 5 AND 6) SHALL RUN INSIDE EXISTING WALL AND UP TO CATWALK LEVEL.

IKANSAS STATTE UNIVERSITY

CAMPUS PLANNING & FACILITIES MANAGEMENT

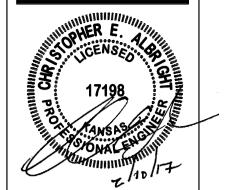

912 BROADWAY BLVD, SUITE 300 KANSAS CITY, MO 64105 P:816 471 6522 | F:816.471.3755 | W: I-A-A.COM

300 OLATHE, KS 66061 P: 913 345 2127 | 913 345 0617

KSU DWG NO.

DR 2015-xxx

SHEET

9 of 12

TOTAL SHEETS IN SET

10 CONNECT TO EXISTING STAGE RISER RECEPTACLE CIRCUIT.

**PERFORMANCE** FLOOR PLAN -

MECH./ELEC.


A-013239

**ME100** 

ORIGINAL CONSTRUCTION **DOCUMENTS** 

GREEN ROOM FLOOR PLAN
MECHANICAL AND ELECTRICAL

PERFORMANCE FLOOR PLAN - MECHANICAL AND ELECTRICAL SCALE : 1/4" = 1'-0"

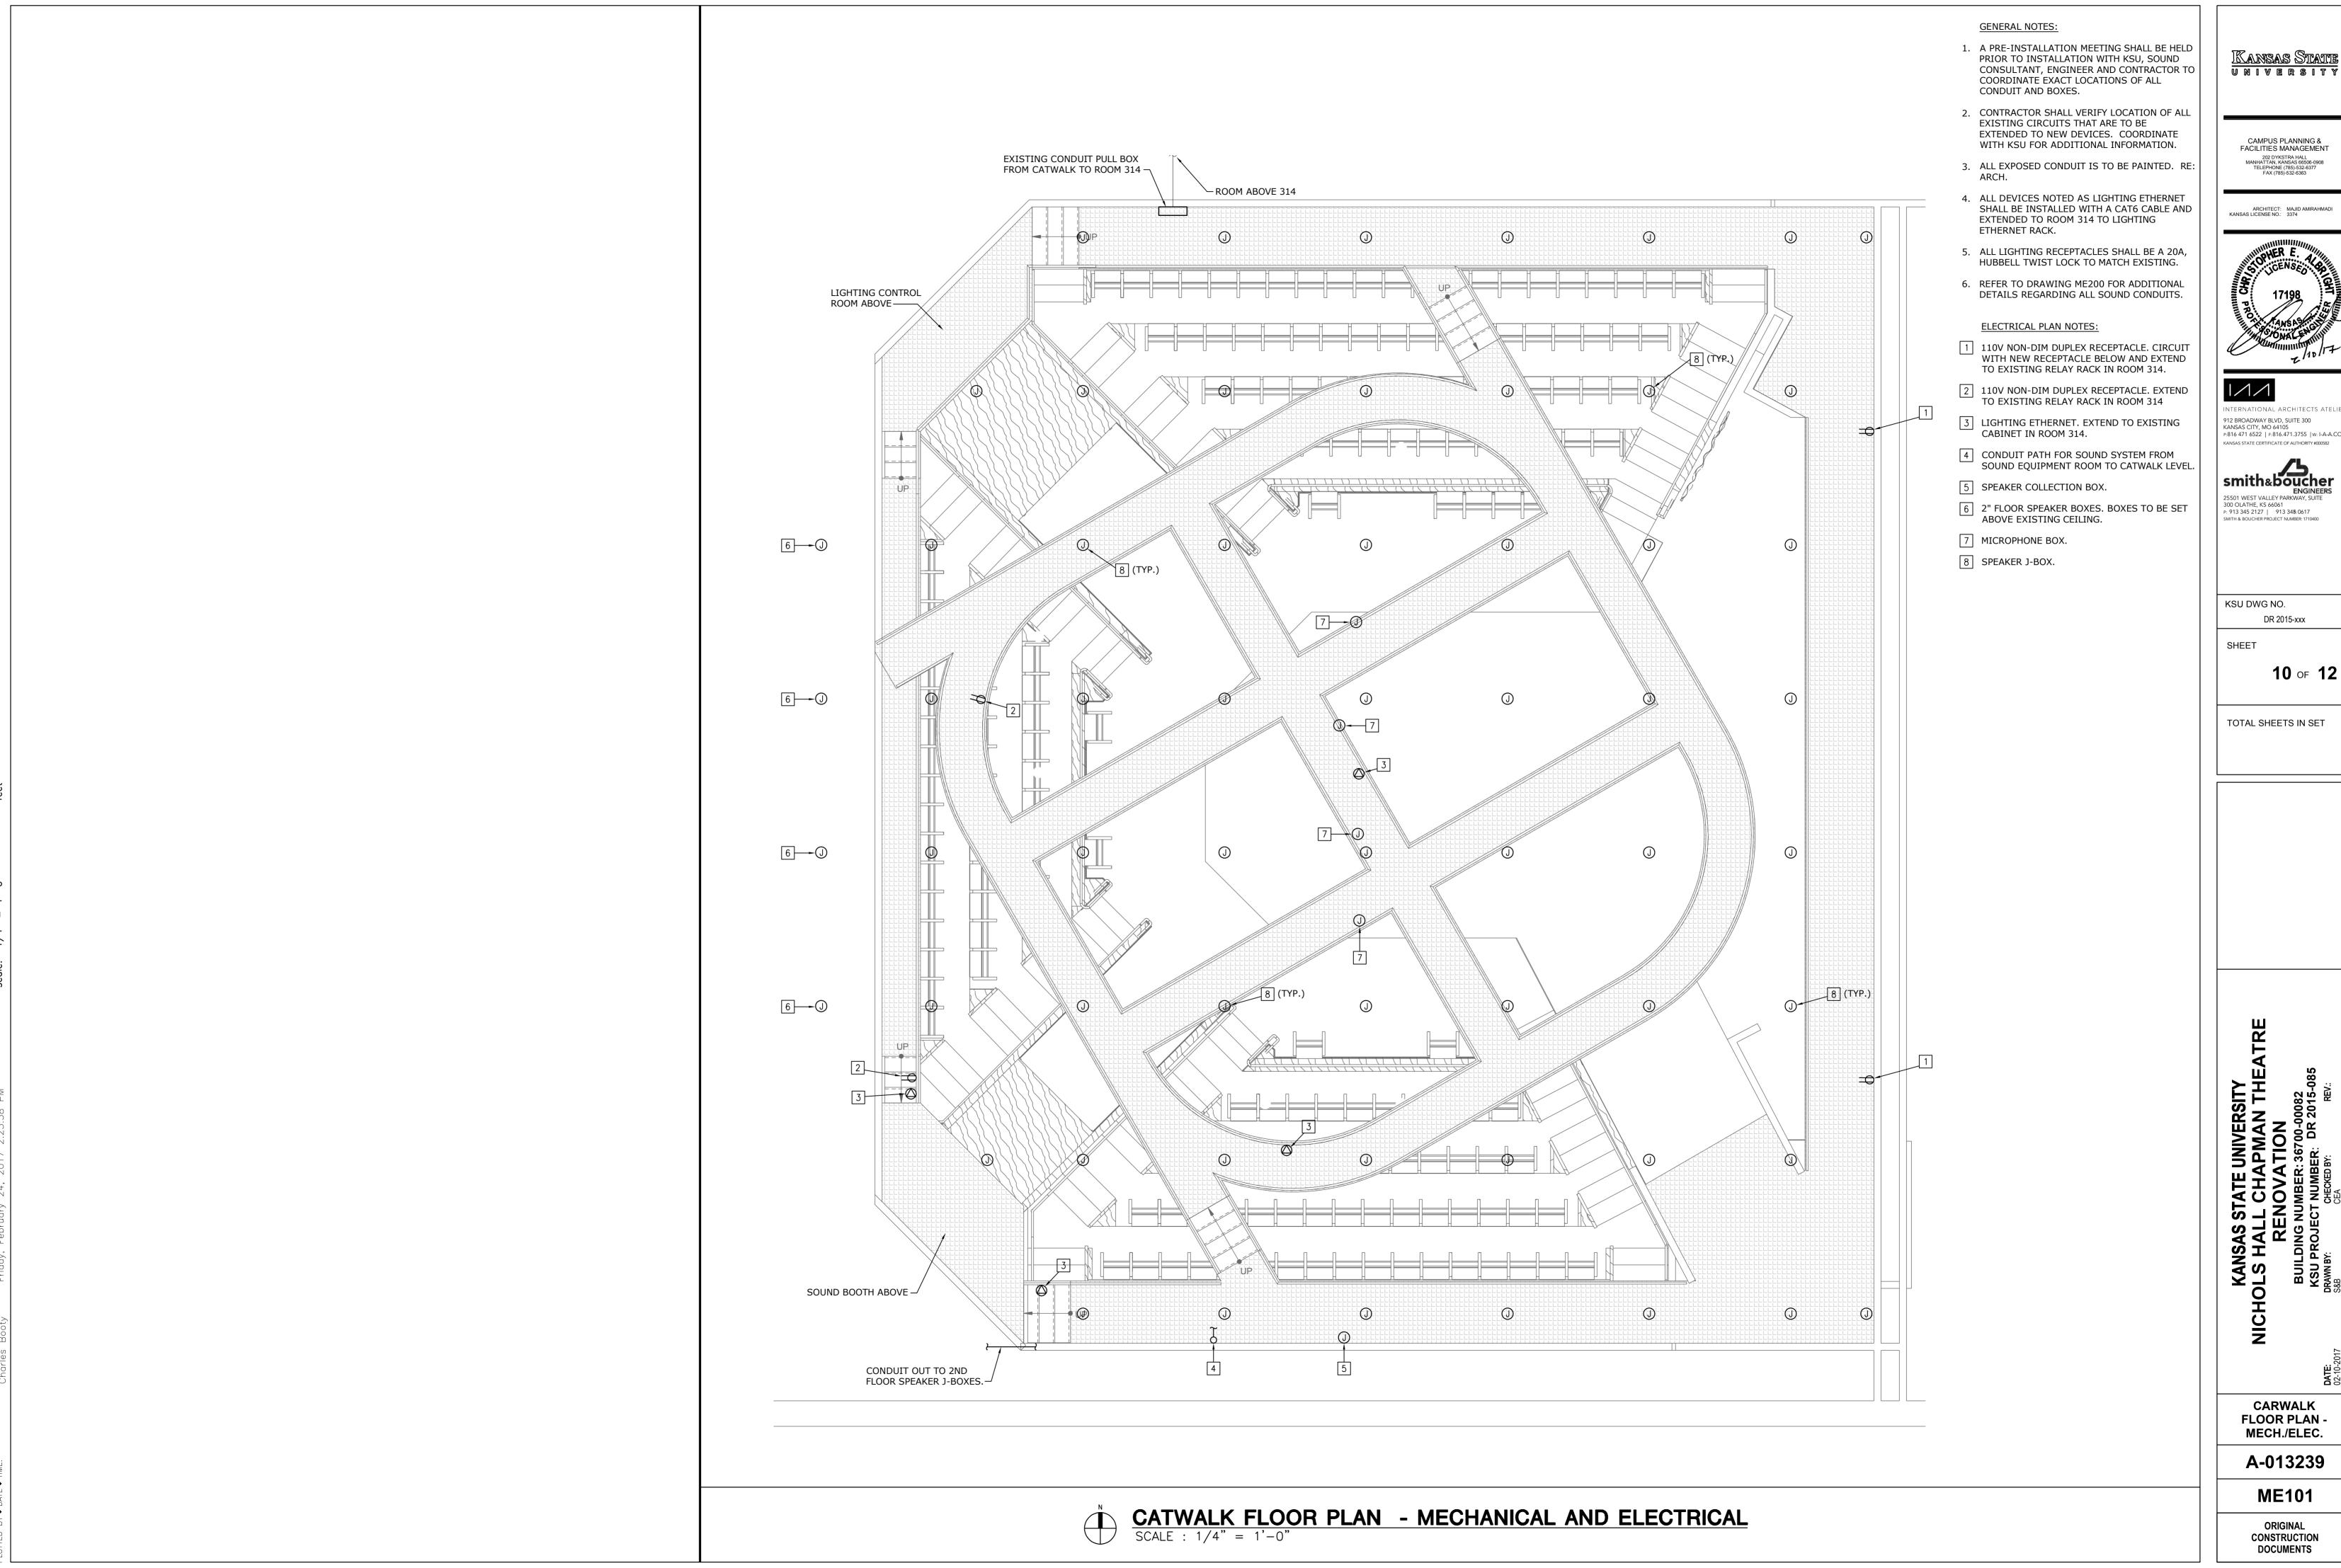

IKansas State

CAMPUS PLANNING & FACILITIES MANAGEMENT



912 BROADWAY BLVD, SUITE 300 KANSAS CITY, MO 64105 P:816 471 6522 | F:816.471.3755 | W: I-A-A.COM

smith&boucher 300 OLATHE, KS 66061
P: 913 345 2127 | 913 345 0617
SMITH & BOUCHER PROJECT NUMBER: 1710400

KSU DWG NO.

DR 2015-xxx

10 of 12


TOTAL SHEETS IN SET

CARWALK FLOOR PLAN -MECH./ELEC.

A-013239

**ME101** 


ORIGINAL CONSTRUCTION DOCUMENTS

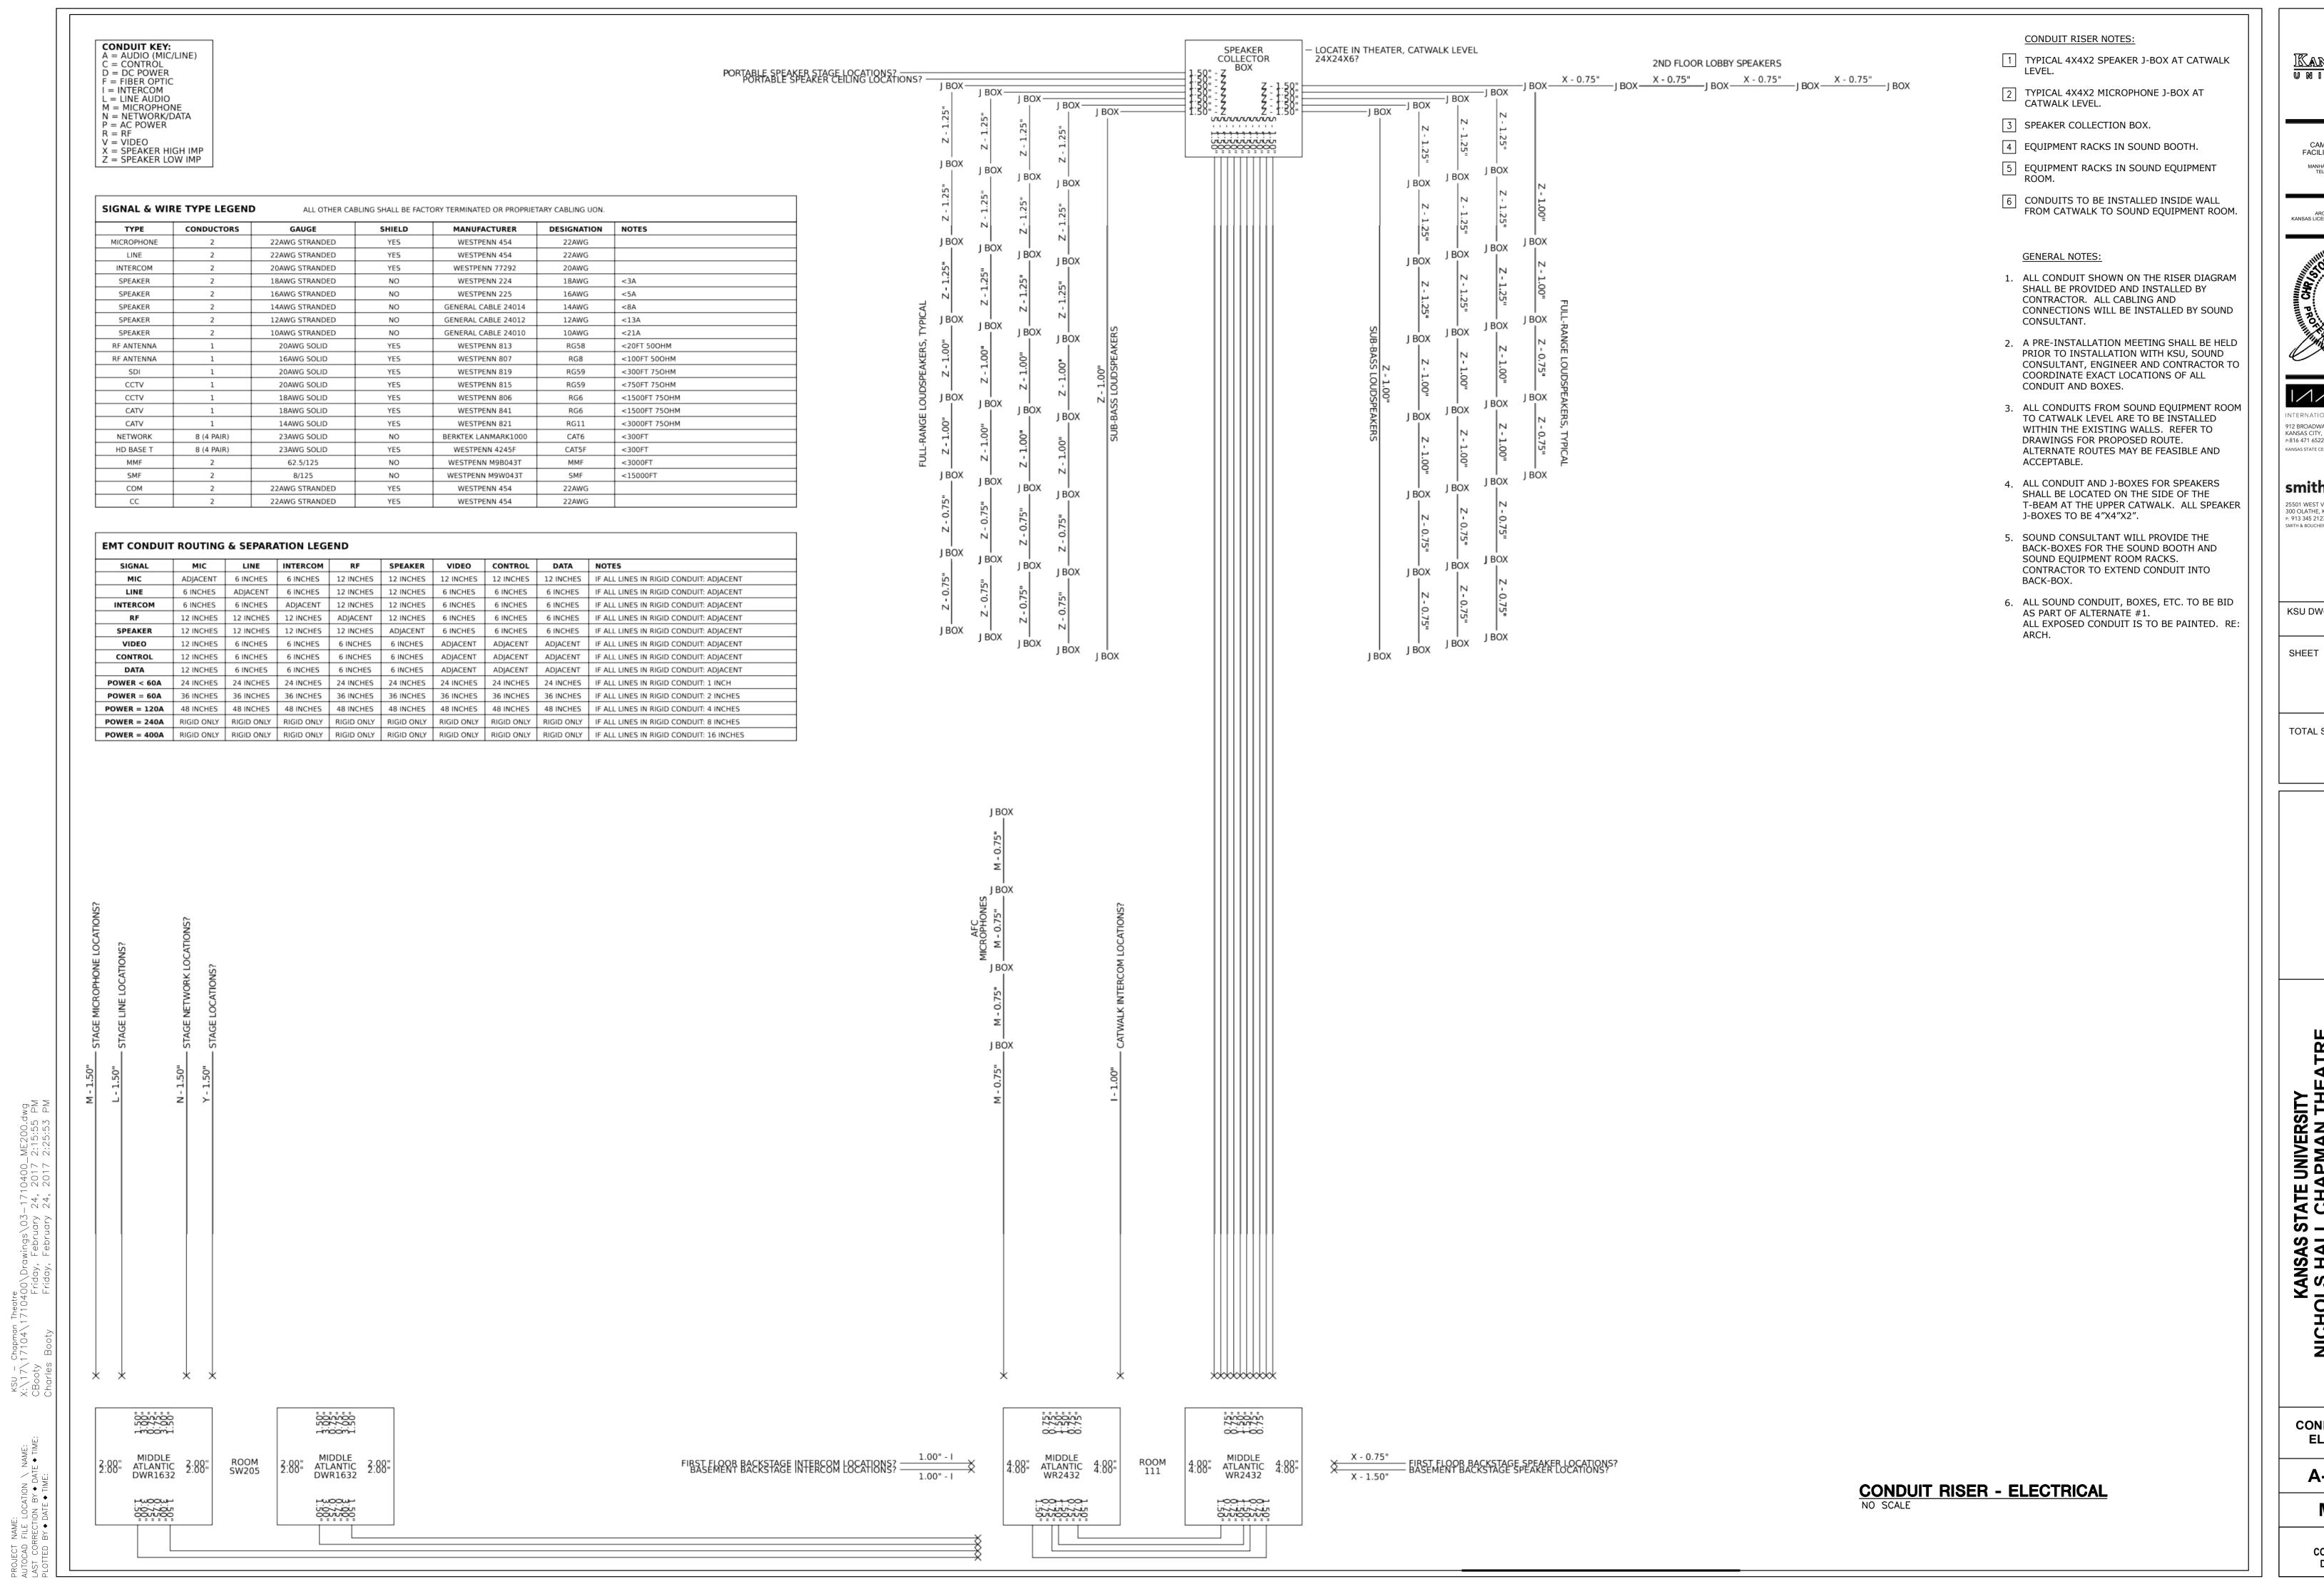

<u>IKansas State</u> university

CAMPUS PLANNING &
FACILITIES MANAGEMENT
202 DYKSTRA HALL
MANHATTAN, KANSAS 66506-0908
TFI EPHONE (7881-532-8377

ARCHITECT: MAJID AMIRAHM

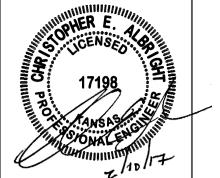

11

912 BROADWAY BLVD, SUITE 300
KANSAS CITY, MO 64105
P:816 471 6522 | F:816.471.3755 | W: I-A-A.COM
KANSAS STATE CERTIFICATE OF AUTHORITY #000582

smith&boucher
ENGINEERS
25501 WEST VALLEY PARKWAY, SUITE
300 OLATHE, KS 66061
P: 913 345 2127 | 913 345.0617
SMITH & BOUCHER PROJECT NUMBER: 1710400

KSU DWG NO.

DR 2015-xxx

11 of 12

TOTAL SHEETS IN SET

AS STATE UNIVERSITY
ALL CHAPMAN THEATRE
RENOVATION
NG NUMBER: 36700-00082
OJECT NUMBER: DR 2015-085

2017

CONDUIT RISER -

ELECTRICAL

A-013239

ME200

ORIGINAL CONSTRUCTION DOCUMENTS

LIGHT FIXTURE SCHEDULE									
TYPE	DESCRIPTION	MOUNTING	SOURCE	VOLTS	MANUFACTURER	V-A			
	(2) LED TRACK HEADS ON A 2' TRACK. WHITE FINISH ON HEAD AND TRACK. 3000K COLOR TEMPERATURE, 1300 LUMENS, FULLY DIMMABLE.	SURFACE	LED		ROYAL PACIFIC #7580 OR PRE-BID APPROVED EQUAL	12			

	PLIT SYSTEM A/C UNIT SC	HEDULE
	GNATION	AC-1
	MANUFACTURER	MITSUBISHI
_	MODEL	PKA-A18GA
JAT/	SERVICE	SOUND EQPT ROOM
UNIT DATA	CFM	370
5	TOTAL COOLING CAP (MBH)	18
	TOTAL HEATING CAP @17°F (MBH)	13
	VOLTAGE/PHASE	208/1
₹	PANEL AND CIRCUIT	NOTE 1
ELEC. DATA	WIRE AND CONDUIT	(2)#12,#12G.,1/2"C
EC.	OVERCURRENT DEVICE	NOTE1
Щ	DISCONNECT	NOTE1
	CONTROLS	THERMOSTAT
OUT	DOOR UNIT	
DESI	GNATION	ACCU-1
	MANUFACTURER	MITSUBISHI
⋖	MODEL NO.	PUZ-A18NHA4
UNIT DATA	TOTAL COOLING CAP (MBH)	18
Ę	TOTAL HEATING CAP (MBH)	13
<b>-</b>	SEER	15.3
I	AMBIENT AIR TEMP (°F.)	95 / 17
	VOLTAGE/PHASE	208/1
_<	PANEL AND CIRCUIT	IS
DA	WIRE AND CONDUIT	(2)#12,#12G.,1/2"C
ELEC DATA	MCA	13
Ш	OVERCURRENT DEVICE	20A-2P CB
	DIGGOLULEGE	

REMARKS

- 1: INDOOR UNIT CIRCUITED THROUGH OUTDOOR UNIT.
- 2: PROVIDE UNIT WITH DIGITAL WALL THERMOSTAT 3: PROVIDE UNIT WITH CONDENSATE PUMP.

DISCONNECT

INTEGRAL

1,2,3

KSU DWG NO. DR 2015-xxx

912 BROADWAY BLVD, SUITE 300 KANSAS CITY, MO 64105 P:816 471 6522 | F:816.471.3755 | W: I-A-A.COM

Smith&boucher
ENGINEERS

25501 WEST VALLEY PARKWAY, SUITE
300 OLATHE, KS 66061
P: 913 345 2127 | 913 345 0617
SMITH & BOUCHER PROJECT NUMBER: 1710400

<u>Kansas Statte</u> university

CAMPUS PLANNING & FACILITIES MANAGEMENT

SHEET

**12** of **12** 

TOTAL SHEETS IN SET

SCHEDULES AND DETAILS-MECH./ELEC.

A-013239

**ME201** 

ORIGINAL CONSTRUCTION DOCUMENTS

		13
feet		
.0		
scale: $1/4$ " = 1'-0"		
scale:		
.15:33 PM :26:24 PM		
24, 2017 2 24, 2017 2 24, 2017 2		
Friday, February 24, 2017 2:15:33 PM Friday, February 24, 2017 2:15:33 PM Friday, February 24, 2017 2:26:24 PM		
/ 1 / 1 0 4 0 0 \ L Frida Frida		
CBooty Forty Charles Booty F		
( U Ö		